


MAXIMUM HOLE SIZE:

D1'	BEARING	NON-BEARING
2x4	1 3/8"	2 1/8"
2x6	2 1/4"	3 1/4"
2x8	2 7/8"	4 3/8"
2x10	3 5/8"	5 1/2"

- NOTES:**
1. PREDRILL CORNERS OF NOTCHES SO AS NOT TO OVER CUT.
 2. NOTCHES ON THE ENDS OF JOISTS AND HEADERS SHALL NOT EXCEED 1/4 OF THE JOIST DEPTH.
 3. NOTCHES IN THE BOTTOM OF JOISTS ALLOWED ONLY WHERE SPECIFICALLY SHOWN ON THE DRAWINGS.
 4. NOTCHES IN THE TOP OF JOISTS SHALL NOT EXCEED 1/16 OF THE DEPTH AND SHALL NOT BE LOCATED IN THE MIDDLE 1/3 OF THE SPAN.
 5. HOLES BORED IN THE JOIST SHALL NOT BE WITHIN 2 INCHES OF THE TOP OR BOTTOM AND SHALL NOT HAVE A DIAMETER LARGER THAN 1/4 OF THE DEPTH OF THE JOIST.


HOLES & NOTCH
NO SCALE

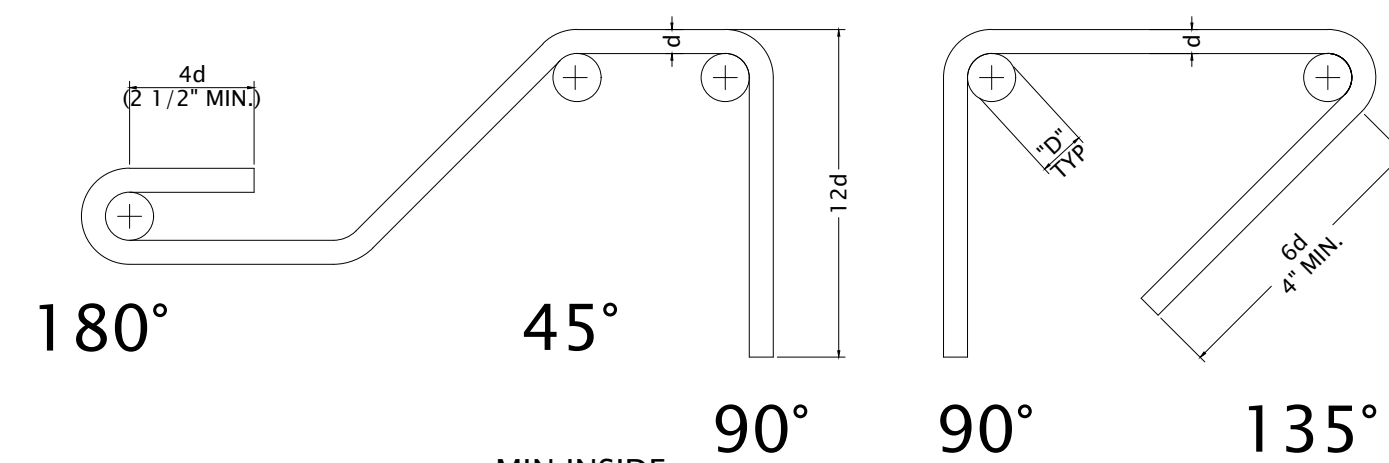


TYP. RE-BAR HOOKS & BENDS
NO SCALE

NOTE:
VERIFY ALL REBAR IN FOOTINGS WITH THE FOUNDATION PLAN


NOTE:
ALL SILL PLATES FOR SHEAR WALLS IN CONTACT WITH CONCRETE SHALL BE DOUGLAS FIR PRESSURE TREATED LUMBER.

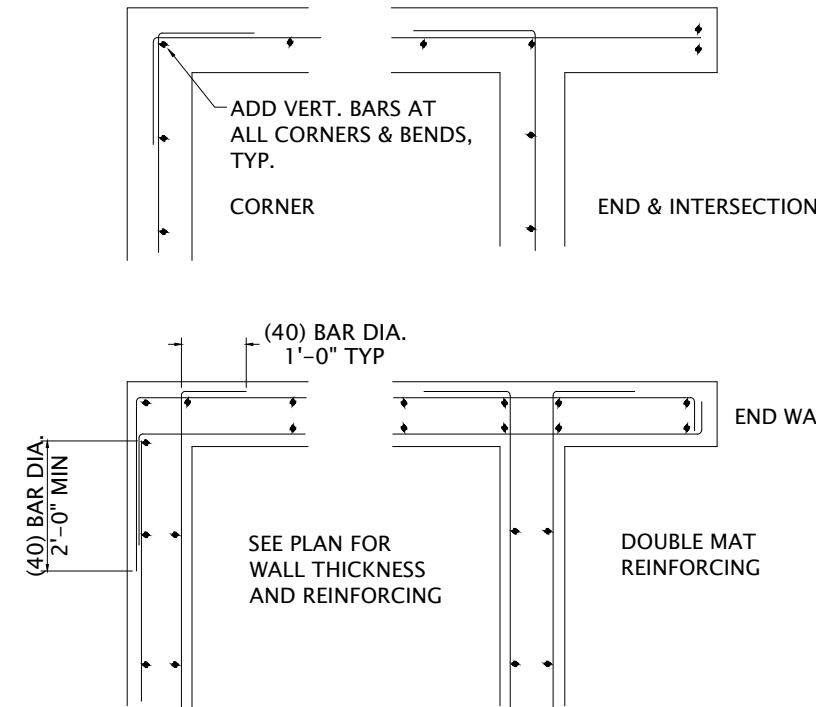


TYP. HORIZ. FOOTING REINF.
NO SCALE

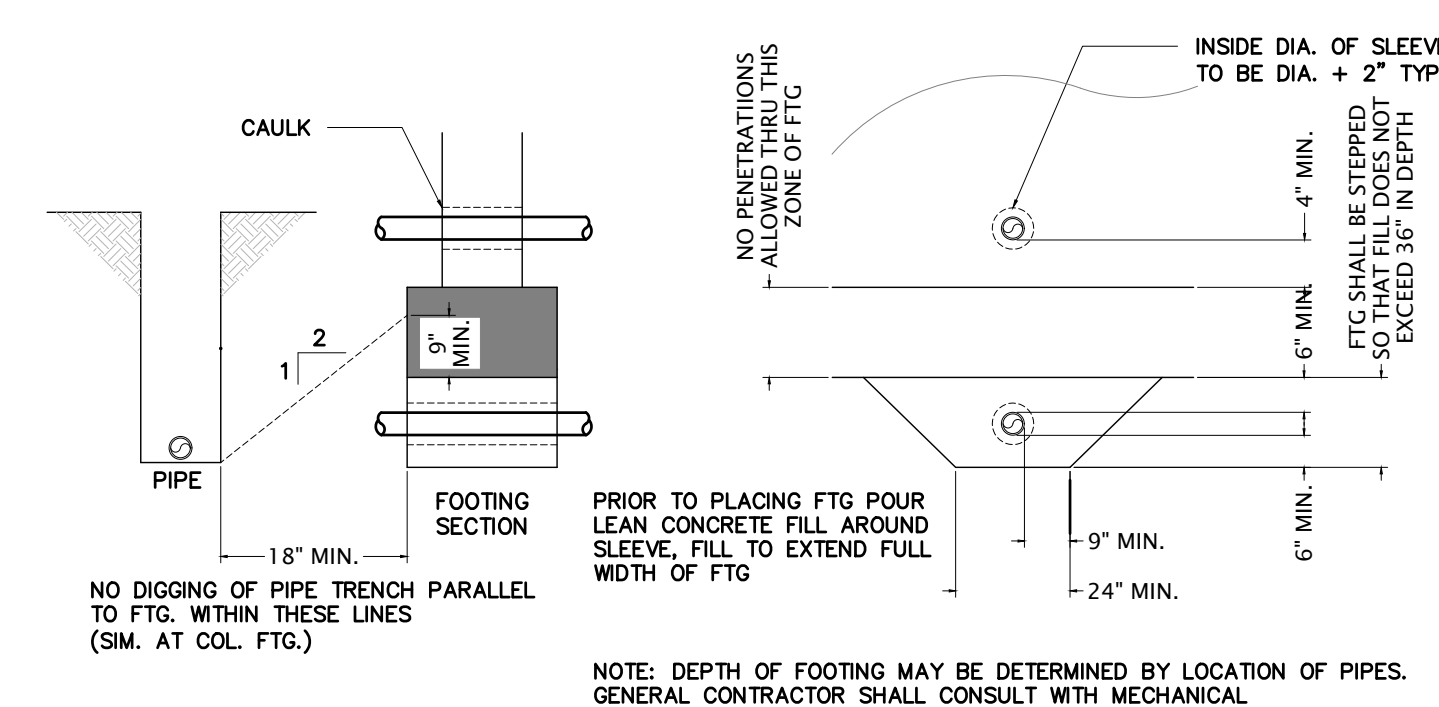


TYP. PIPE THRU FOOTING
NO SCALE

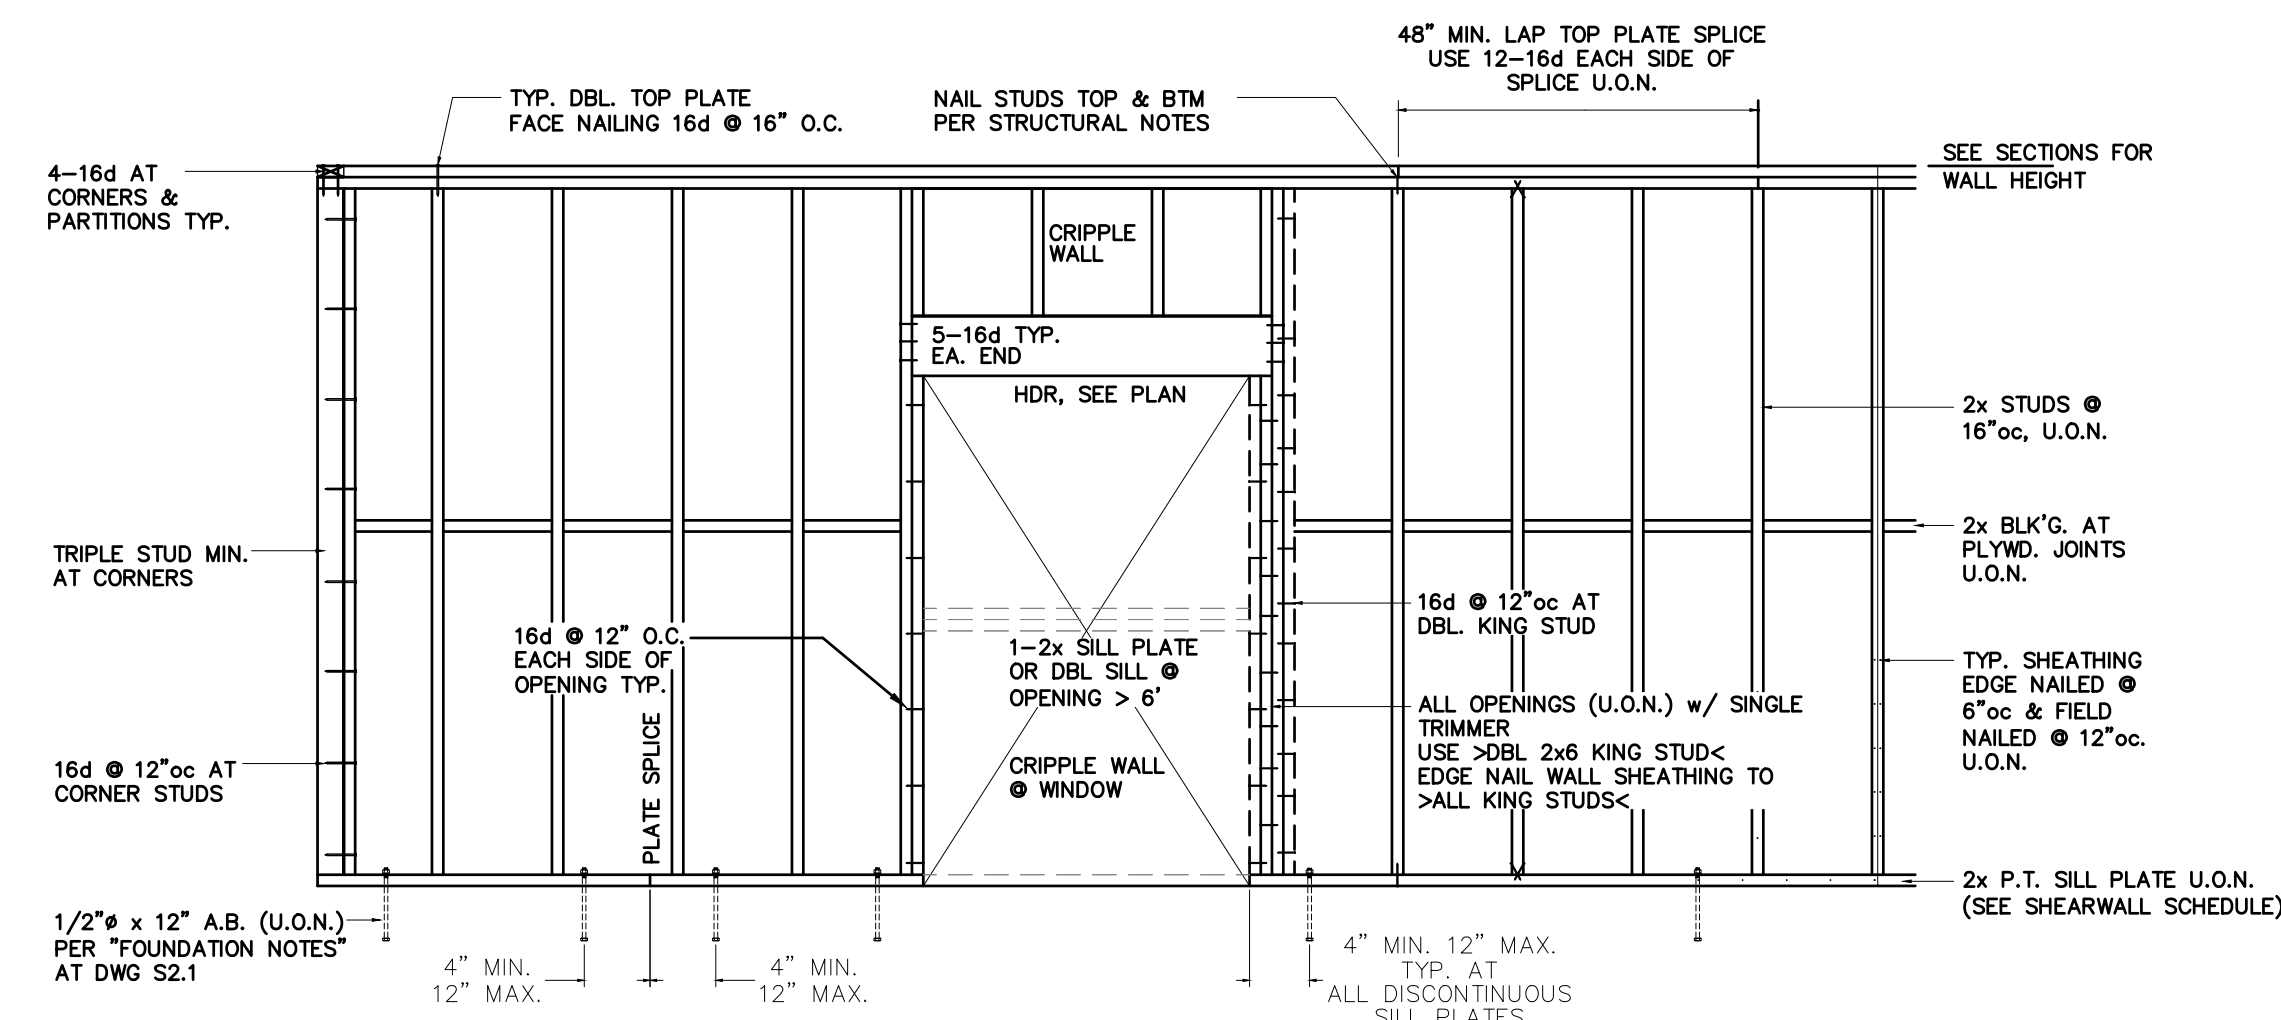


TYP. BEARING WALL DETAILS
NO SCALE

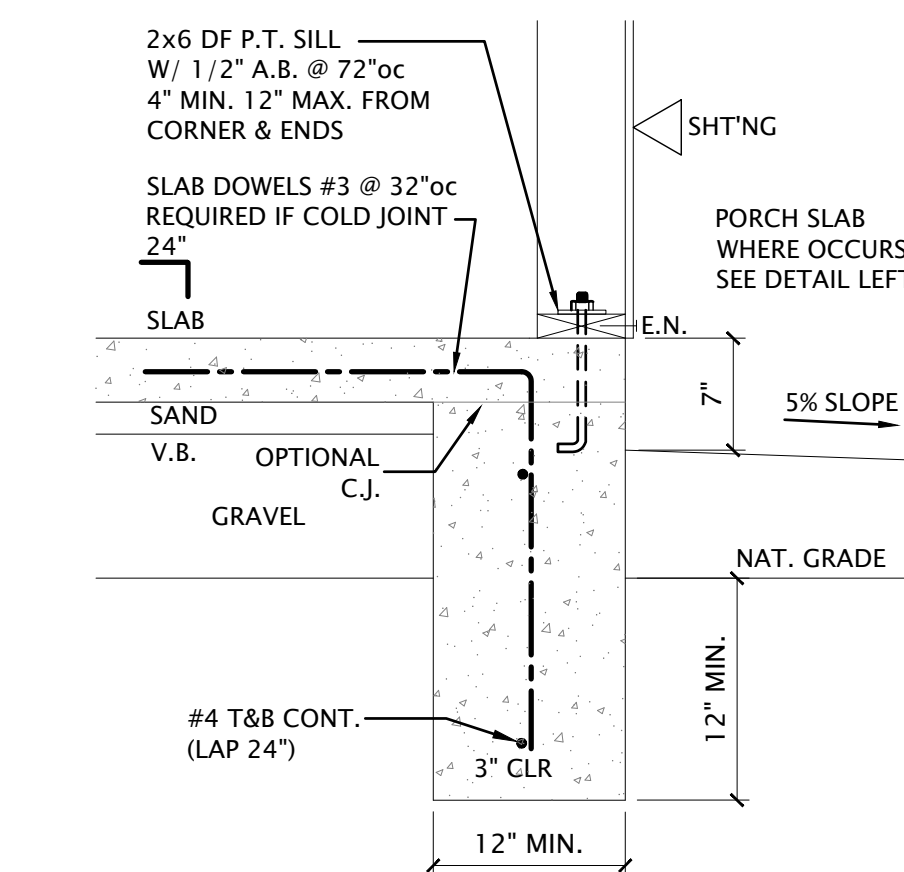

2 PERIMETER FOOTING
SCALE: 1"=1'-0"

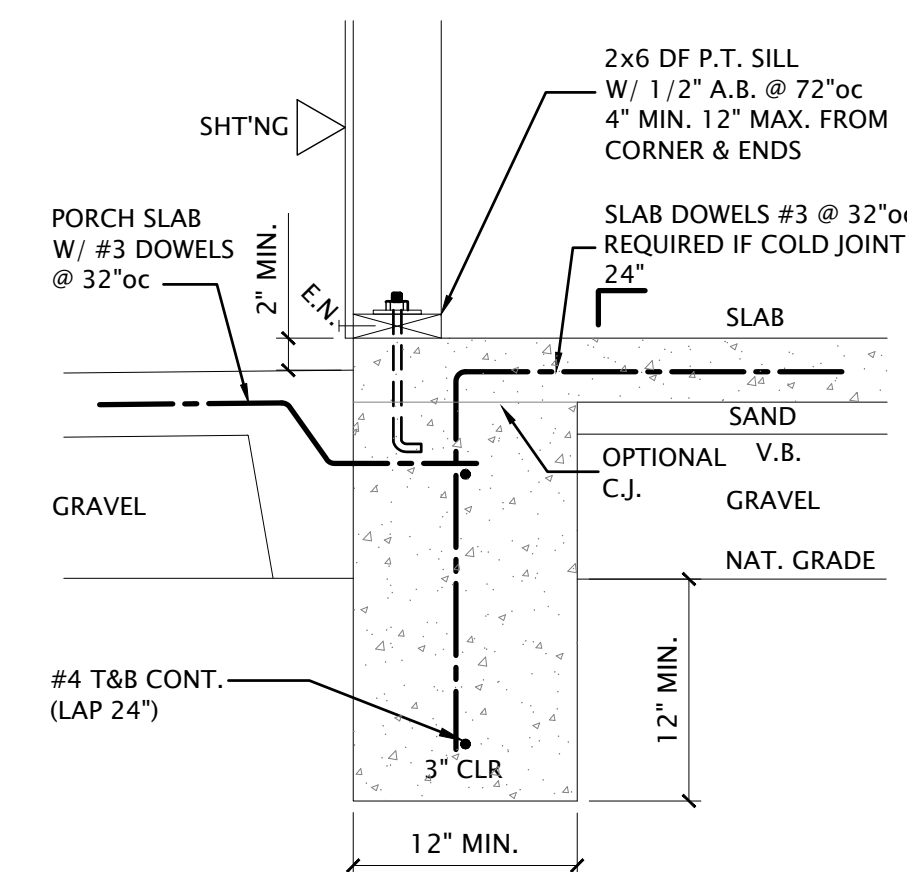

1 FOOTING
SCALE: 1"=1'-0"

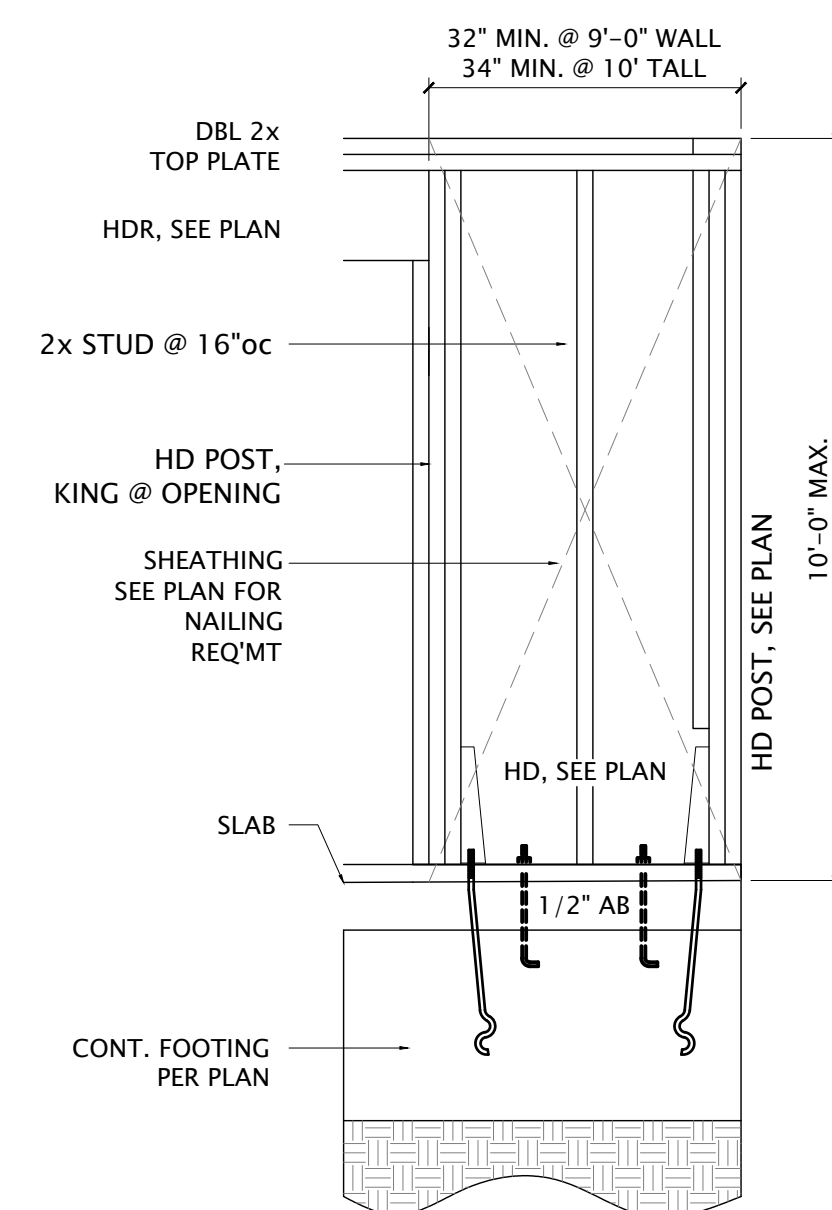

AB ALTERNATE BRACE WALL
NO SCALE


SHEET NAME & PROJECT
STRUCTURAL DETAILS
 SMALL ACCESSORY DWELLING UNIT - (461 SQ FT ONE BEDROOM)
 CITY OF RED BLUFF
 555 WASHINGTON
 RED BLUFF, CA 96080
 APR.

CMC ARCHITECTURE
 3815 BIRCH CREEK DRIVE I
 RED BLUFF, CA 96080
 (530) 440-9256
 ARCHITECTURE | CMCARK.COM


SHEET
S3.1
 PERMIT SET

DATE: 08/22/2022
 JOB NUMBER:
 CADD FILE:
 SEAL
 08/22/2022
 LICENSED ARCHITECT
 ANTONETTE
 ANTONETTE
 C-35355
 RENEWAL: 2/28/23
 STATE OF CALIFORNIA


REVISIONS
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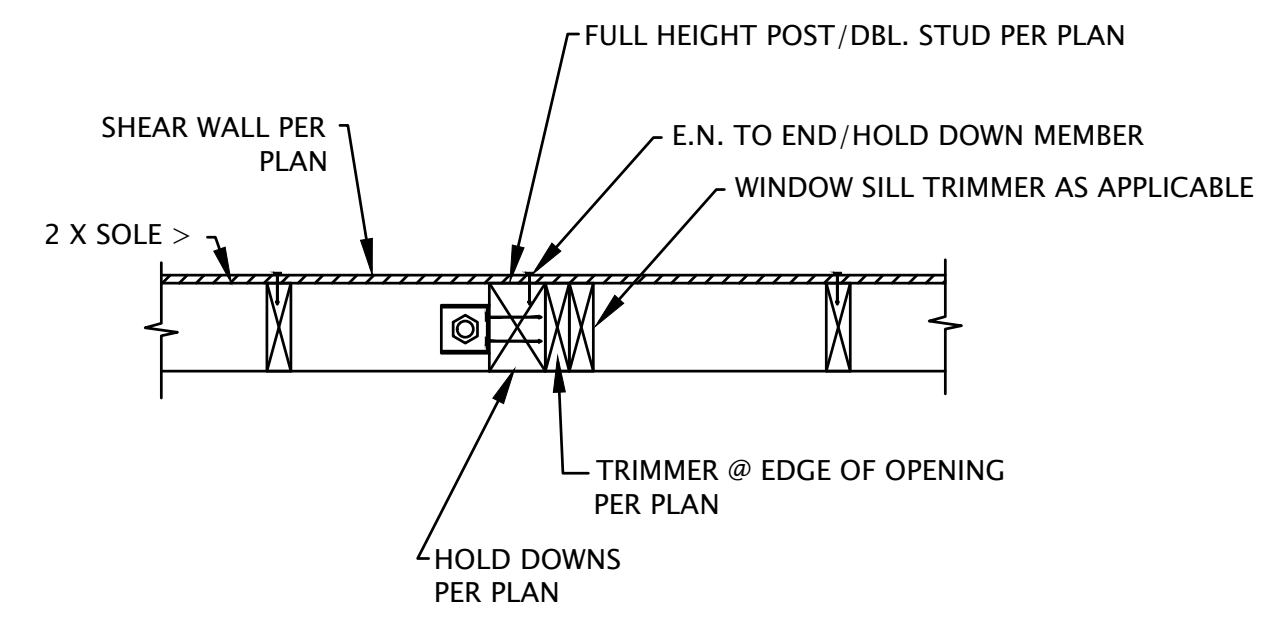
1 TYPICAL LOW EAVE DETAIL

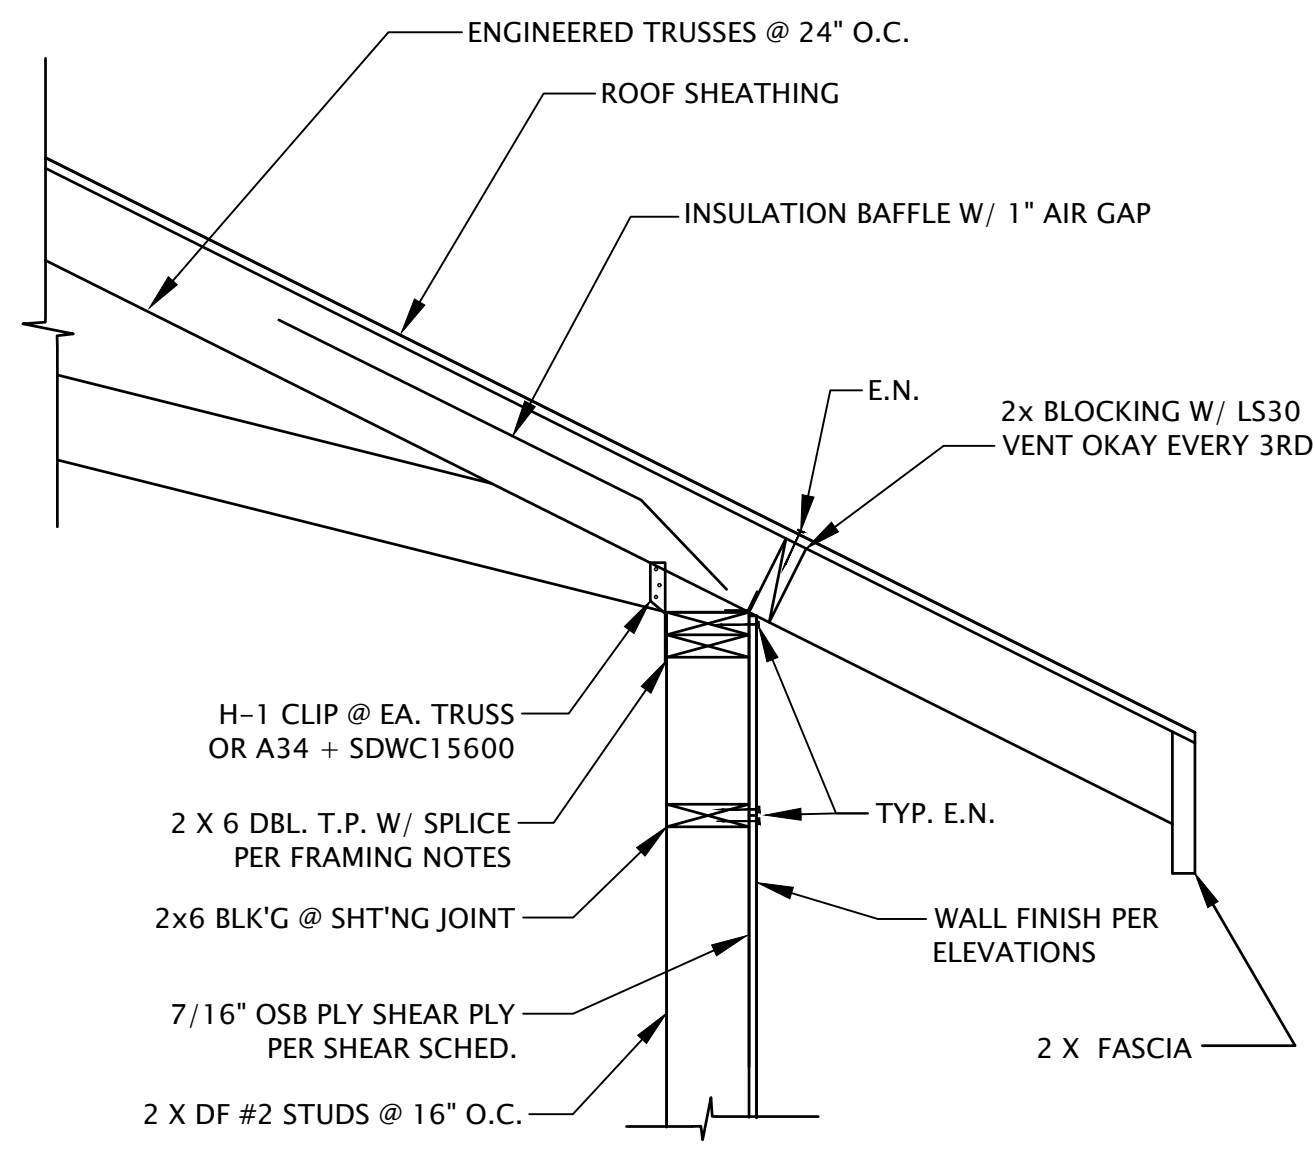


2 TYP. GABLE END SHEAR TRANSFER

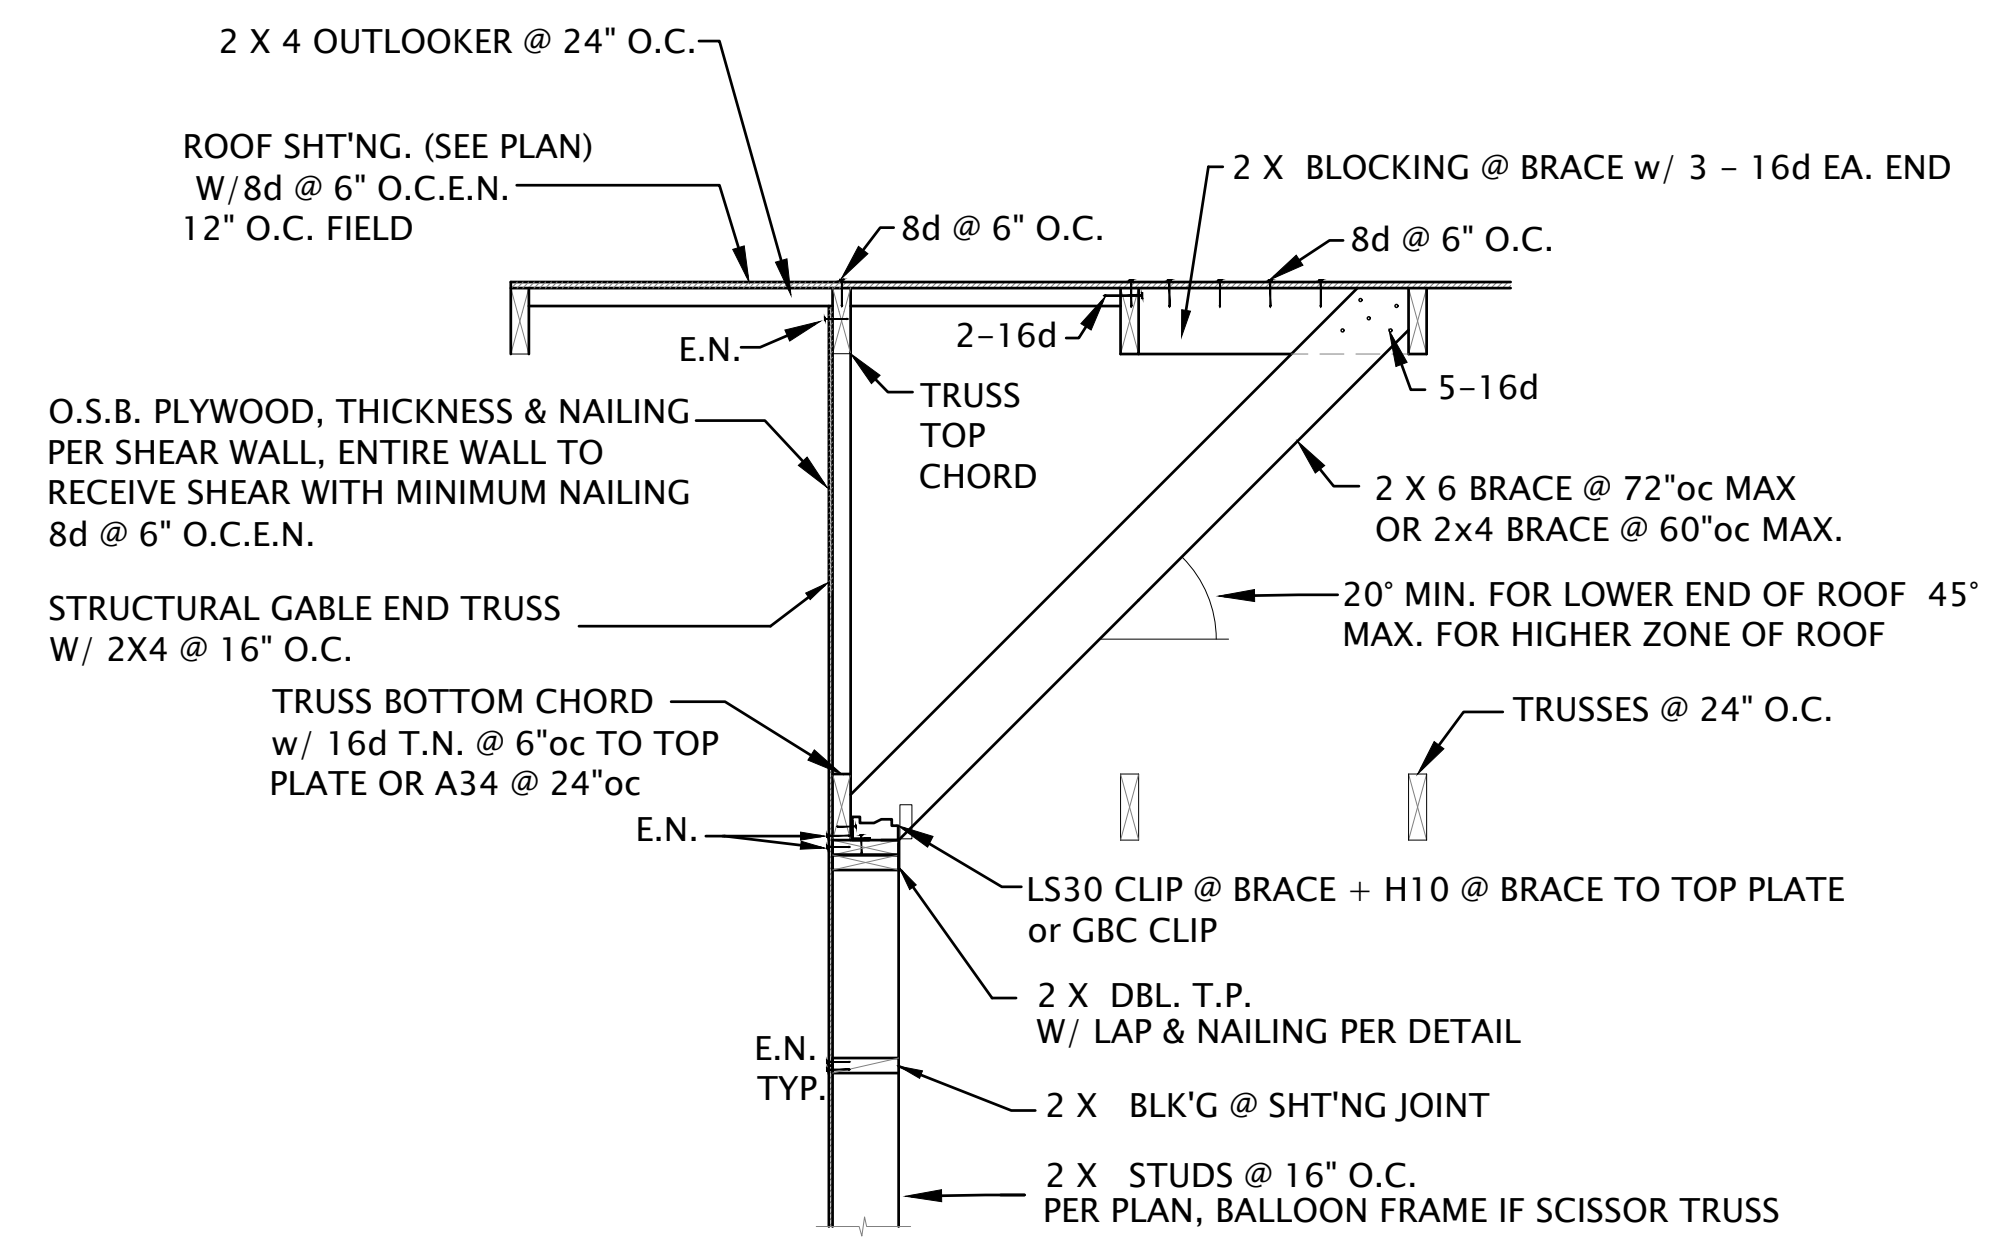


FRAMING @ CORNER W/ HOLD DOWN CASE 1

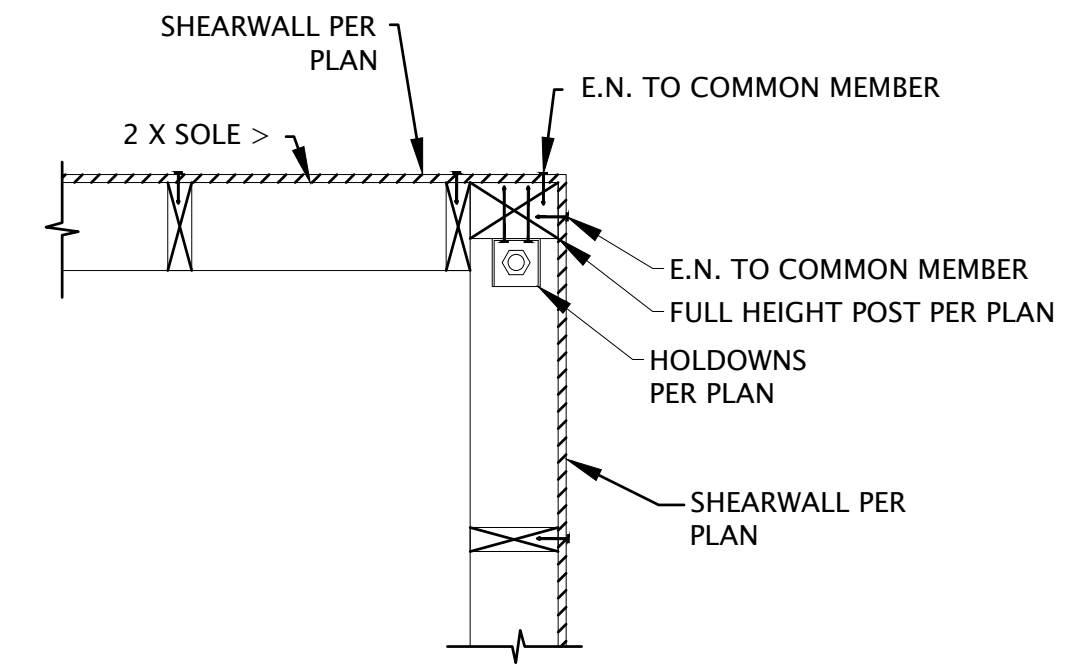


FRAMING @ INTERIOR W/ HOLD DOWN CASE 2

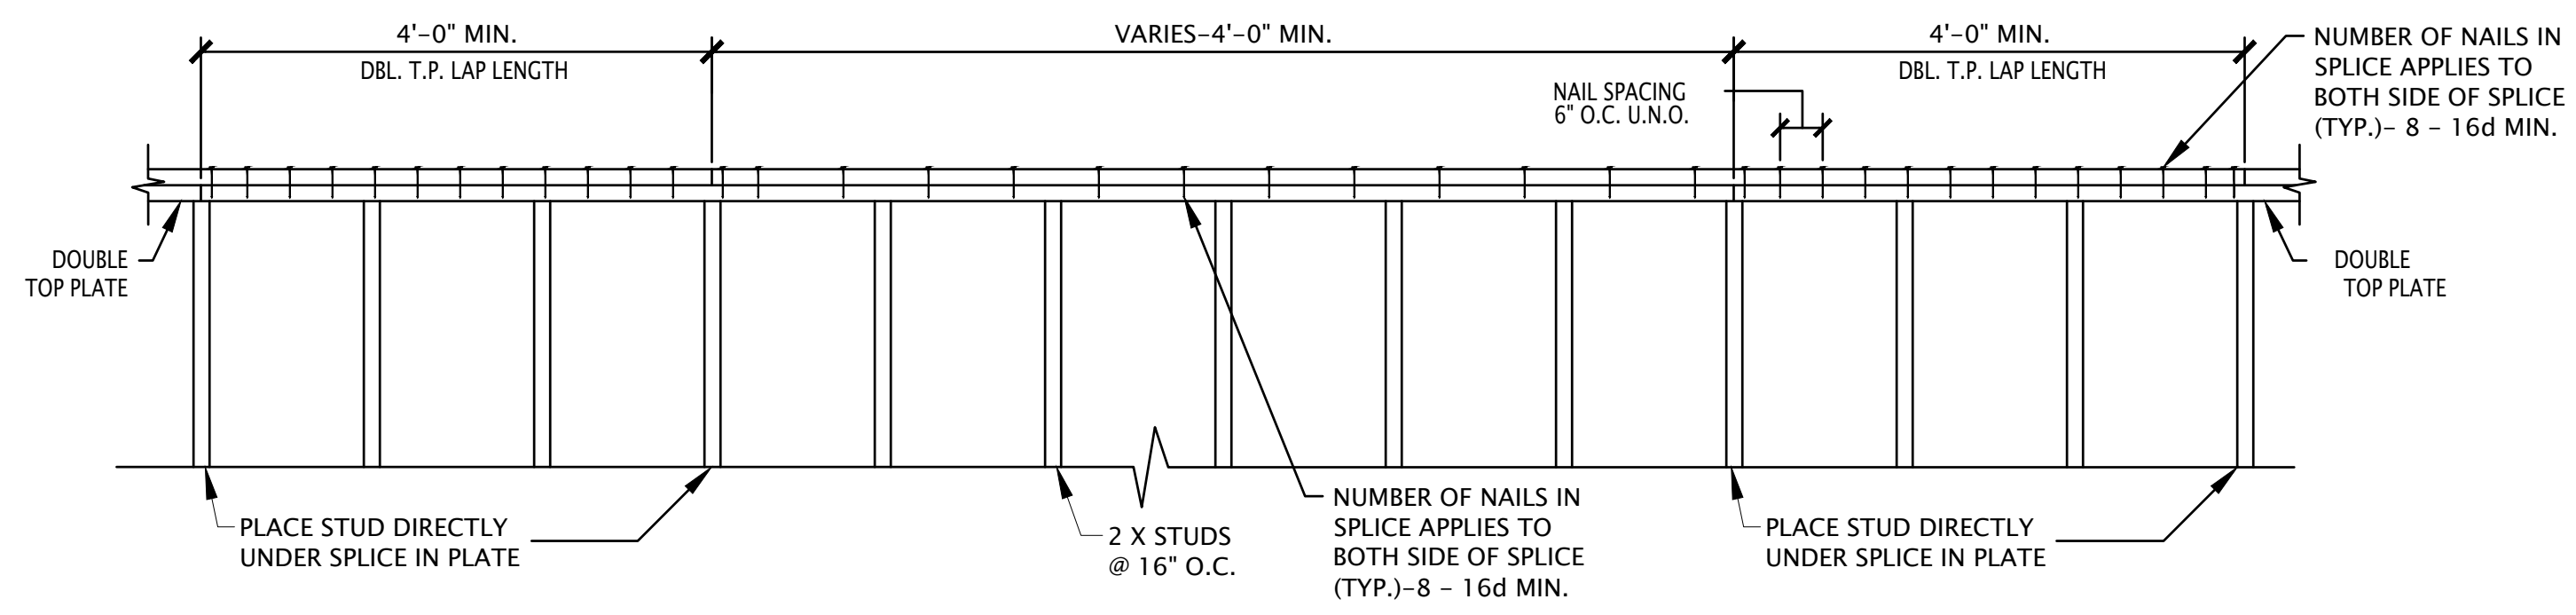


CHORD/DBL. T.P. LAP SPLICE
(TYPICAL THRU-OUT PLAN U.N.O. PER SCHEDULE)

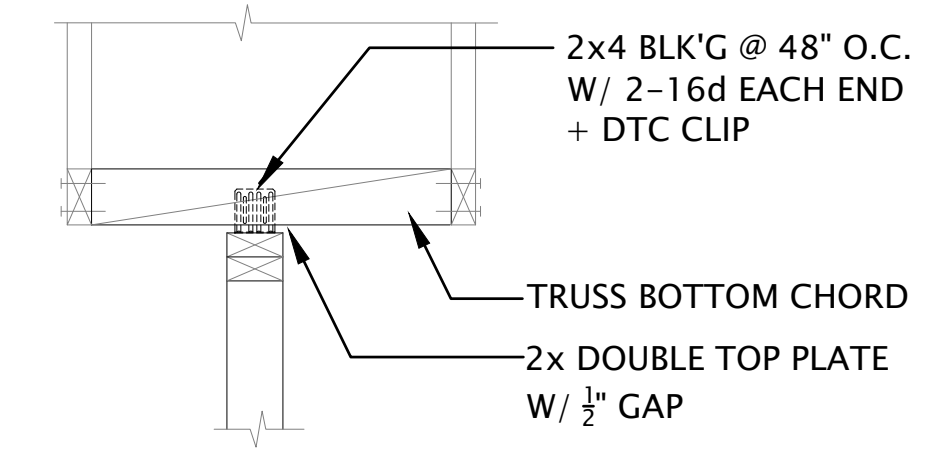

NON-BEARING TOP OF WALL
WALL PARALLEL TO TRUSS

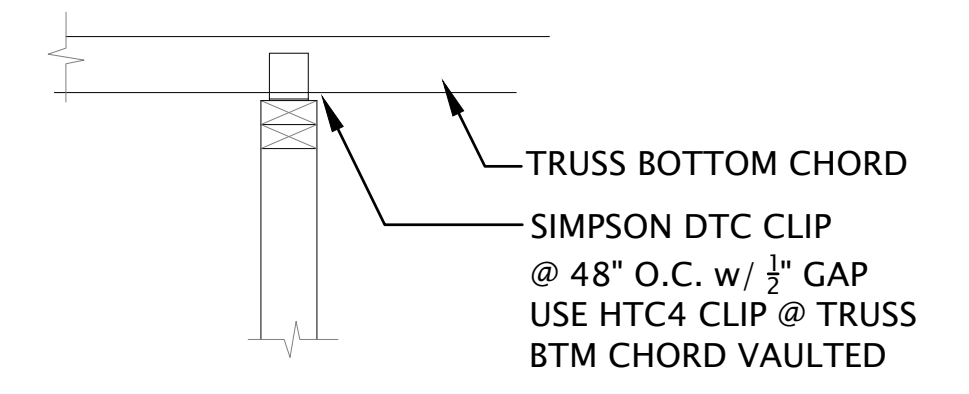

NON-BEARING TOP OF WALL
WALL PERPENDICULAR TO TRUSS

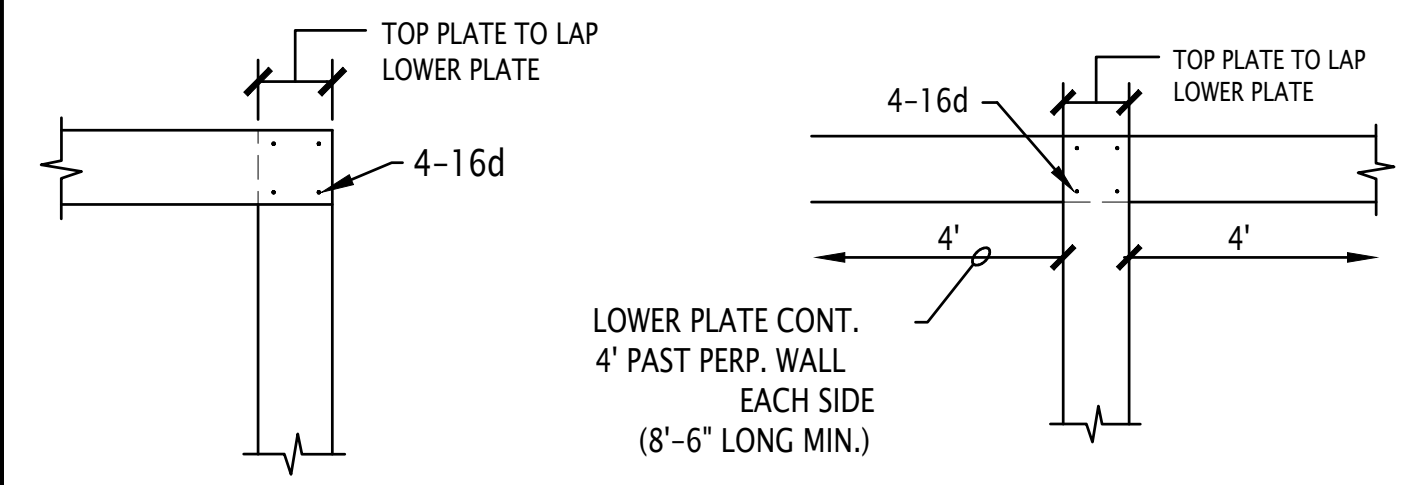

TYPICAL CORNER TYPICAL INTERSECTION
TOP PLATE TIES

- NOTES:
- 1) INSTALL TRUSSES, WEB & LATERAL BRACING IN STRICT ACCORDANCE WITH THE TRUSS MANUFACTURER SPECIFICATIONS, INCLUDING ALL REQUIRED HANGERS.
 - 2) ALL EXTERIOR HEADERS SHALL BE 6 X 12 DF #2 U.N.O.
 - 3) ALL FASTENERS FOR THE ROOFING SHALL PENETRATE THROUGH THE ROOF SHEATHING.

REVISIONS

DATE	08/22/2022
JOB NUMBER	
CADD FILE	

DATE: 08/22/2022
JOB NUMBER:
CADD FILE:
SEAL: 08/22/2022

ANTONETTE CAROLINA MORRIS
C-35355
RENEWAL: 2/28/23
STATE OF CALIFORNIA

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3201 BIRCH STREET SUITE 1
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(530) 440-9256

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SHEET

S3.2

PERMIT SET