

CITY OF NEWPORT 2060 1ST Avenue Newport, MN 55055 (651) 459-5677 ci.newport.mn.us

President:
Board of
Commissioners:

Laurie Elliott Kevin Chapdelaine Tom Ingemann Marvin Taylor Rozlyn Johnson E.D. Director / City Administrator: Asst. to the City Admin: Authority Attorney: Deb Hill Travis Brierley Flaherty & Hood

Newport Economic Development Authority Agenda September 15, 2022- 4:30 PM

- 1. CALL TO ORDER
- 2. ROLL CALL
- 3. ADOPT AGENDA
- 4. CONSENT AGENDA A. Minutes- April 7, 2022
- 5. PUBLIC HEARING- Sale of 975 2nd Ave
- 6. ADJOURNMENT



CITY OF NEWPORT NEWPORT ECONOMIC DEVELOPMENT AUTHORITY MINUTES NEWPORT CITY HALL April 7, 2022

1. CALL TO ORDER

President Elliott called the Newport Economic Development Authority Meeting to order at 7:57 p.m. on April 7, 2022.

2. ROLL CALL

Present (5): President Laurie Elliott, Commissioner Kevin Chapdelaine, Commissioner Tom Ingemann, Commissioner Marvin Taylor, and Commissioner Rozlyn Johnson.

Not Present (0): None.

3. ADOPT AGENDA

Commissioner Chapdelaine motioned to adopt the agenda. Seconded by Commissioner Johnson. Approved 5-0.

4. NEDA MINUTES

a. February 17, 2022

<u>Commissioner Chapdelaine motioned to approve the minutes of the February 17, 2022 NEDA Meeting.</u> <u>Seconded by Commissioner Ingemann. Approved 5-0.</u>

5. POTENTIAL CLOSED MEETING

(Meeting closed pursuant to develop or consider offers or counteroffers for the sale of real property located at 2nd Avenue and 9th Street under Minn. Stat. 13D.05, Subd. 3 (b))

<u>Commissioner Ingemann motioned to close the NEDA Meeting.</u> <u>Seconded by Commissioner Chapdelaine.</u> <u>Approved 5-0.</u>

The NEDA Meeting was closed at 7:58 p.m. on April 7, 2022.

<u>Commissioner Chapdelaine motioned to open the NEDA Meeting.</u> <u>Seconded by Commissioner Ingemann.</u> Approved 5-0.

The NEDA Meeting was opened at 8:05 p.m. on April 7, 2022.

6. ADJOURNMENT

Commissioner Taylor motion	ned to ad	journ the New	port Economic	Develop	ment A	Authority	Meeting.	Seconded by
Commissioner Chapdelaine.	Approve	ed 5-0.	=	_			-	-

e Newport Economic Development Authority Meeting was adjourned at 8:07 p.m. on April 7, 2022.
spectfully Submitted: Thiesfeld ministrative Assistant II
Signed:
Laurie Elliott, President

LEGAL DESCRIPTION:

Lots 1, 3, 5 and 7, Block 13, Town of Newport, Washington County, Minnesota

SCOPE OF WORK & LIMITATIONS:

- 1. Showing the length and direction of boundary lines of the legal description listed above. The scope of our services does not include determining what you own, which is a legal matter. Please check the legal description with your records or consult with competent legal counsel, if necessary, to make sure that it is correct and that any matters of record, such as easements, that you wish to be included on the survey have been shown.
- Showing the location of observed existing improvements we deem necessary for the survey.
- Setting survey markers or verifying existing survey markers to establish the corners of the property.
- Showing elevations on the site at selected locations to give some indication of the topography of the site. We have also provided a benchmark for your use in determining elevations for construction on this site. The elevations shown relate only to the benchmark provided on this survey. Use that benchmark and check at least one other feature shown on the survey when determining other elevations for use on this site or before beginning construction.
- 5. This survey has been completed without the benefit of a current title commitment. There may be existing easements or other encumbrances that would be revealed by a current title commitment. Therefore, this survey does not purport to show any easements or encumbrances other than the ones shown hereon.
- 6. While we show the minimum building setback lines per our interpretation of the city's zoning code, said setback lines must be verified by the appropriate city official to be sure that they are shown correctly. Do this before using the survey to make any decisions regarding the property.
- We have shown the bluff line and bluff setback line per a provided survey. This survey does not purport to have field verified said bluff information. If verification of the bluff information is needed for your project, we suggest you do that before proceeding with any design or construction.
- While we show a proposed location for this home or addition, we are not as familiar with your proposed plans as you, your architect, or the builder are. Review our proposed location of the improvements and proposed yard grades carefully to verify that they match your plans before construction begins. Also, we are not as familiar with local codes and minimum requirements as the local building and zoning officials in this community are. Be sure to show this survey to said officials, or any other officials that may have jurisdiction over the proposed improvements and obtain their approvals before beginning construction or planning improvements to the property.
- 9. Note that all building dimensions and building tie dimensions to the property lines, are taken from the siding and or stucco of the building.

STANDARD SYMBOLS & CONVENTIONS:

"•" Denotes iron survey marker, found, unless otherwise noted.

GRADING & EROSION CONTROL NOTES:

BEFORE DEMOLITION AND GRADING BEGIN

- Install silt fence/bio roll around the perimeter of the construction area.
- Sediment control measures must remain in place until final stabilization has been established and then shall be removed. Sediment controls may be removed to accommodate short term construction activity but must be replaced before the next rain.
- A temporary rock construction entrance shall be established at each access point to the site and a 6 inch layer of 1 to 2 inch rock extending at least 50 feet from the street into the site and shall be underlain with permeable geotextile fabric. The entrance shall be maintained during construction by top dressing or washing to prevent tracking or flow of sediments onto public streets, walks or alleys. Potential entrances that are not so protected shall be closed by fencing to prevent unprotected exit from the site.
- Contractor shall install inlet protection on all existing storm sewer inlets in accordance with the city standard details. Inlet protection shall also be provided on all proposed storm sewer inlets immediately following construction of the inlet. Inlet protection must be installed in a manner that will not impound water for extended periods of time or in a manner that presents a hazard to vehicular or pedestrian traffic.

HOUSE

FRONT PORCH

FRONT WALK

EXISTING GARAGE

FUTURE PATIO

PROPOSED HARDCOVER

FUTURE SCREEN PORCH

PERCENTAGE OF HARDCOVER TO LOT

DRIVEWAY

AREA OF LOT

- When dirt stockpiles have been created, a double row of silt fence shall be placed to prevent escape of sediment laden runoff and if the piles or other disturbed areas are to remain in place for more than 14 days, they shall be seeded with Minnesota Department of Transportation Seed Mixture 22-111 at 100 lb/acre followed by covering with spray mulch.
- A dumpster shall be placed on the site for prompt disposal of construction debris. These dumpsters shall be serviced regularly to prevent overflowing and blowing onto adjacent properties. Disposal of solid wastes from the site shall in accordance with Minnesota Pollution Control Agency requirements.
- A separate container shall be placed for disposal of hazardous waste. Hazardous wastes shall be disposed of in accordance with MPCA requirements.
- Concrete truck washout shall be in the plastic lined ditch and dispose of washings as solid waste. • Sediment control devices shall be regularly inspected and after major rainfall events and shall be

cleaned and repaired as necessary to provide downstream protection.

PROPOSED HARDCOVER

- Streets and other public ways shall be inspected daily and if litter or soils has been deposited it
- If necessary, vehicles, that have mud on their wheels, shall be cleaned before exiting the site in the
- Moisture shall be applied to disturbed areas to control dust as needed.
- Portable toilet facilities shall be placed on site for use by workers and shall be properly
- If it becomes necessary to pump the excavation during construction, pump discharge shall be into the stockpile areas so that the double silt fence around these areas can filter the water before it leaves the site.
- Temporary erosion control shall be installed no later than 14 days after the site is first disturbed and shall consist of broadcast seeding with Minnesota Department of Transportation Seed Mixture 22-111 at 100 lb/acre followed by covering with spray mulch.
- Erosion control measures shown on the erosion control plan are the absolute minimum. The contractor shall install temporary earth dikes, sediment traps or basins and additional silt fencing as deemed necessary to control erosion.


SITE WORK COMPLETION:

- - - 717 - - -

X 717.5

-----717----

- When final grading has been completed but before placement of seed or sod an "as built" survey shall be done per City of Newport requirements to insure that grading was properly done.
- When any remedial grading has been completed, sod or seeding shall be completed including any erosion control blankets for steep areas.
- When turf is established, silt fence and inlet protection and other erosion control devices shall be disposed of and adjacent streets, alleys and walks shall be cleaned as needed to deliver a site that
- Contractor shall maintain positive drainage of a minimum 2% slope away from proposed building.

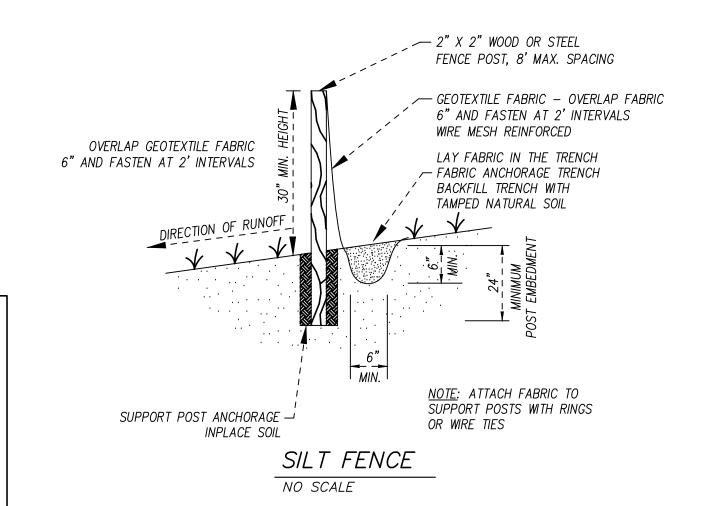

6" MINIMUM-WASHED ROCK PLACE ROCK OVER GEOTEXTILE FABRIC TYPE IV.

INSTALL SILT ----

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INSTALL SILT

FENCE/BIO ROLL

20

INSTALL SILT

20

FENCE/BIO ROLL

EXISTING GARAGE 10TH ST.

SF — SF — SF

LOT AREA: 25,97兆SQ. FT

--SETBACK LINES (AS SHOWN ON PRIOR SURVEY)

N 89°16'55" E

130.03

PROPOSED DWELLING

FFE=719.7

719.0

24.2

GARAGE FLOOR

129.63

S 89°32'42" W


ELEV.=716.3.

----BLUFF LINE (PER MSA ADMINISTRATIVE SUBDIVISION SURVEY - DATED MARCH, 2022)

ROCK CONSTRUCTION ENTRANCE NO SCALE

LICENSE NO.

AUGUST 12, 2022

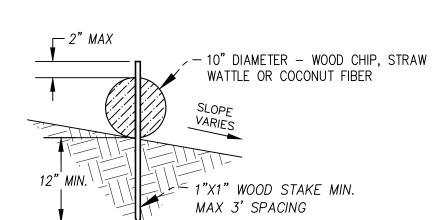

BENCHMARK: TOP NUT HYDRANT

ELEV.=719.62

BENCHMARK: SOUTH RIM OF

MH ELEV.=718.46

- INSTALL SILT FENCE/BIO ROLL

- INSTALL SILT FENCE/BIO ROLL

-INSTALL ROCK CONSTRUCTION

-INSTALL SILT FENCE/BIO ROLL

PROPOSED WATER SERVICE

PER CITY STANDARDS)

57 LF @ 1" COPPER (TYPE K)

(CONNECT TO EXISTING STUB

PROPOSED SANITARY SEWER SERVICE 60 LF @ 2.0% MIN. 4" PVC SDR 35

(CONNECT TO EXISTING STUB @

STUB TO MAIN PORTION IS NOT

DAMAGED PER CITY STANDARDS)

INV=708.9±, TELEVISE TO ENSURE

ENTRANCE PER NOTES

--EDGE OF ROADWAY

-718.5

~718.9

45.9

BIO ROLL *NO SCALE*

REVISION DESCRIPTION 1 INCH = 20 FEET

3,068 SQ. FT.

183 SQ. FT.

1,044 SQ. FT. 587 SQ. FT.

157 SQ. FT.

64 SQ. FT.

5,163 Sq. Ft.

25,971 Sq. Ft.

19.8%

60 SQ. FT.

DRAWING ORIENTATION & SCALE

<u>LEGEND</u>

EXISTING CONTOUR

EXISTING SPOT ELEVATION

PROPOSED SPOT ELEVATION

DRAINAGE ARROW - FLOW

SILT FENCE/BIO ROLL

PROPOSED CONTOUR

B. KYLE

CLIENT/JOB ADDRESS

975 2ND AVE. N. NEWPORT, MN Surveying & Engineering, Co.

17917 Highway No. 7 Minnetonka, Minnesota 55345 Phone (952) 474-7964 Web: www.advsur.com

HEREBY CERTIFY THAT THIS PLAN, SURVEY OR REPORT WAS PREPARED BY ME OR UNDER MY DIRECT SUPERVISIO AND THAT I AM A DULY REGISTERED LAND SURVEYOR JNDER THE LAWS OF THE STATE OF MINNESOTA. Wayne W. Preuks #43503

AUGUST 12, 2022


SURVEYED DATE: SHEET TITLE CERTIFICATE OF SURVEY JUNE 7, 2022 SHEET SIZE: 22 X 34 DRAFTED DATE:

DRAWING NUMBER

221467 JR

SHEET NO.

SHEET 1 OF 1

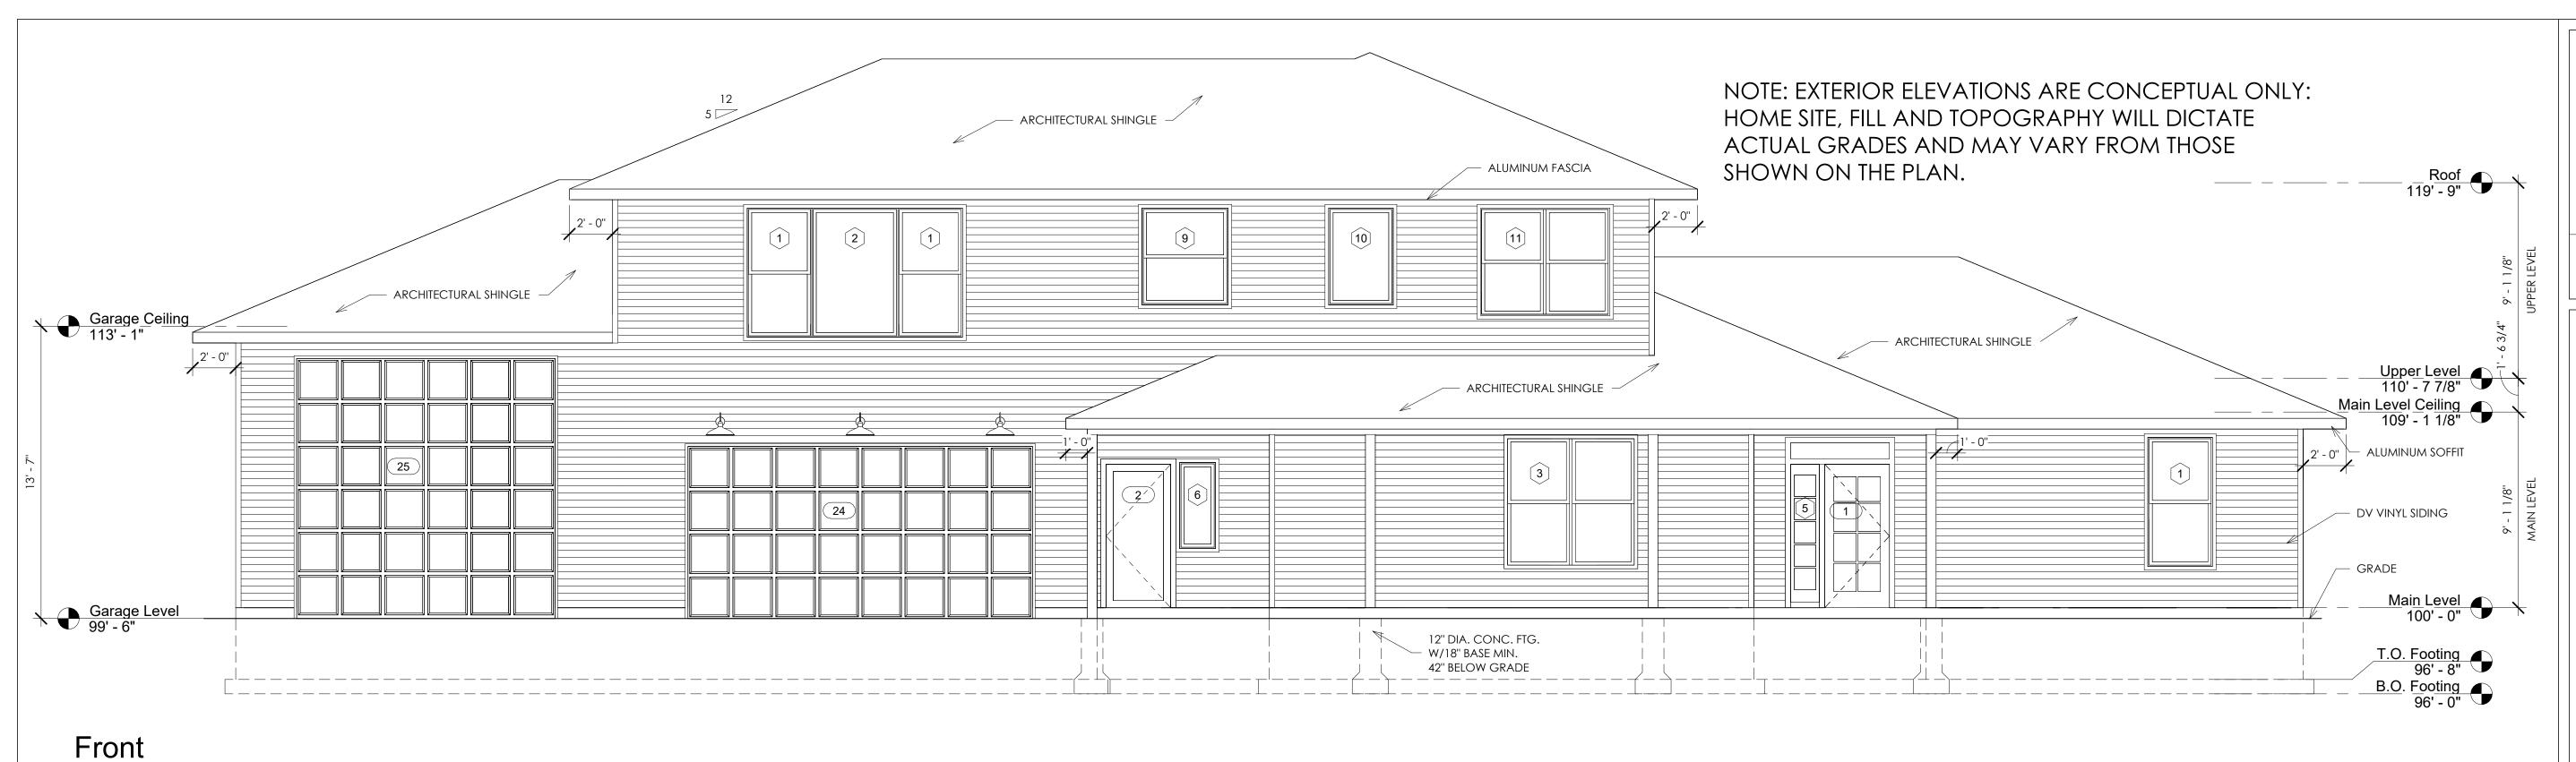

Door Number	Door Size	Comments
1	36" x 80"	Main Entry W/Sidelite & Transon
2	36" x 80"	Front Entry
3	108" X 80"	Patio Door W/Transom
4	36" x 80"	Dining Entry Door
5	36" x 80"	Back Garage Entry
6	36" x 80"	1 Hour Fire Door
7	32" x 80"	
8	28" x 80"	Pocket Door
9	36" x 80"	Pocket Door
10	30" x 80"	
11	30" x 80"	
12	28" x 80"	Pocket Door
13	28" x 80"	Pocket Door
14	60" x 80"	French Door
15	32" x 80"	
16	48" x 80"	French Door
17	36" x 80"	
18	30" x 80"	
19	30" x 80"	
20	30" x 80"	
21	30" x 80"	
22	28" x 80"	Pocket Door
23	30" x 80"	
24	16' X 8' Overhead Garage Door	Garage Door

Garage Door

12' X 12' Overhead Garage Door

Door Schedule

1/4" = 1'-0"

			Window Schedule			
Туре		ugh ening		Glazin g	Head	
Mark	Width	Height	Туре	Туре	Height	Count
1	3' - 0''	6' - 0''	Single Hung		7' - 11''	9
2	4' - 0''	6' - 0''	Fixed		7' - 11''	4
3	6' - 0''	6' - 0''	Single Hung Double		7' - 11''	2
4	6' - 0''	2' - 0''	Fixed		7' - 11''	1
5	1' - 4''	6' - 8''	Sidelights 1			1
6	1' - 8''	4' - 0''	Fixed		6' - 9''	1
7	3' - 0''	5' - 0''	Single Hung		7' - 11''	2
8	4' - 0''	5' - 0''	Fixed		7' - 11''	1
9	4' - 0''	4' - 6''	Single Hung		7' - 11''	1
10	3' - 0''	4' - 6''	Fixed		7' - 11''	1
11	6' - 0''	5' - 0''	Single Hung Double		7' - 11''	1

SOIL TYPE:

DESIGNED WITH 2000 PSI SOILS, ALL FOUNDATION CONSTRUCTION MUST FACTOR IN THIS AT A MINIMUM.

WIND EXPOSURE:

DESIGNED WITH "EXPOSURE B" CLASSIFICATIONS AND WIND. GUSTS OF 90 MPH PER 2015 RESIDENTIAL CODE REGULATIONS.

SQUARE FOOTAGE:

MAIN LEVEL = 1,925 UPPER LEVEL = 1,394 GARAGE = 1,078 TOTAL FINISHED= 3,319 TOTAL FOOTPRINT= 3,067

DOORS & WINDOWS:

- 1. ALL WINDOWS AND DOORS TO BE DOUBLE PANE GLASS PANELS WITH LOW E-RATINGS.
- 2. ANY WINDOW WITHIN 24" OF A DOOR SWING MUST BE TEMPERED PER CODE.
- 3. ANY WINDOW ABOVE A TUB/WET AREA MUST BE TEMPERED PER CODE.
- 4. ANY WINDOW WITHIN A STAIRWAY MUST BE TEMPERED PER CODE.
- 5. WINDOW GLAZING MUST BE AT LEAST 18" A.F.F. WHEN WINDOW IS ABOVE 6' FROM GRADE. IF WITHIN 18" WINDOW MUST BE TEMPERED.
- 6. ALL BEDROOMS TO HAVE AT LEAST ONE WINDOW THAT HAS A CLEAR EGRESS OPENING OF 5.7 SQ. FT. WITH MIN. DIMENSIONS OF 24" IN HEIGHT AND 20" IN WIDTH, SILL HEIGHT NOT TO BE GREATER THAN 14" A.F.F.
- 7. WINDOWS WITH SILLS WITHIN 3' OF THE FLOOR THEY SERVE AND ARE 72" ABOVE GRADE MUST EITHER HAVE A FALL PREVENTION OR OPENING LIMITER DEVICE PER CODE.



651-307-1640

No.	Description	Date


SLAB ON GRADE

Elevations

Project Number Project number 08/23/2022 SWK Drawn by Checker Checked by **A1**

Scale

1/4" = 1'-0"

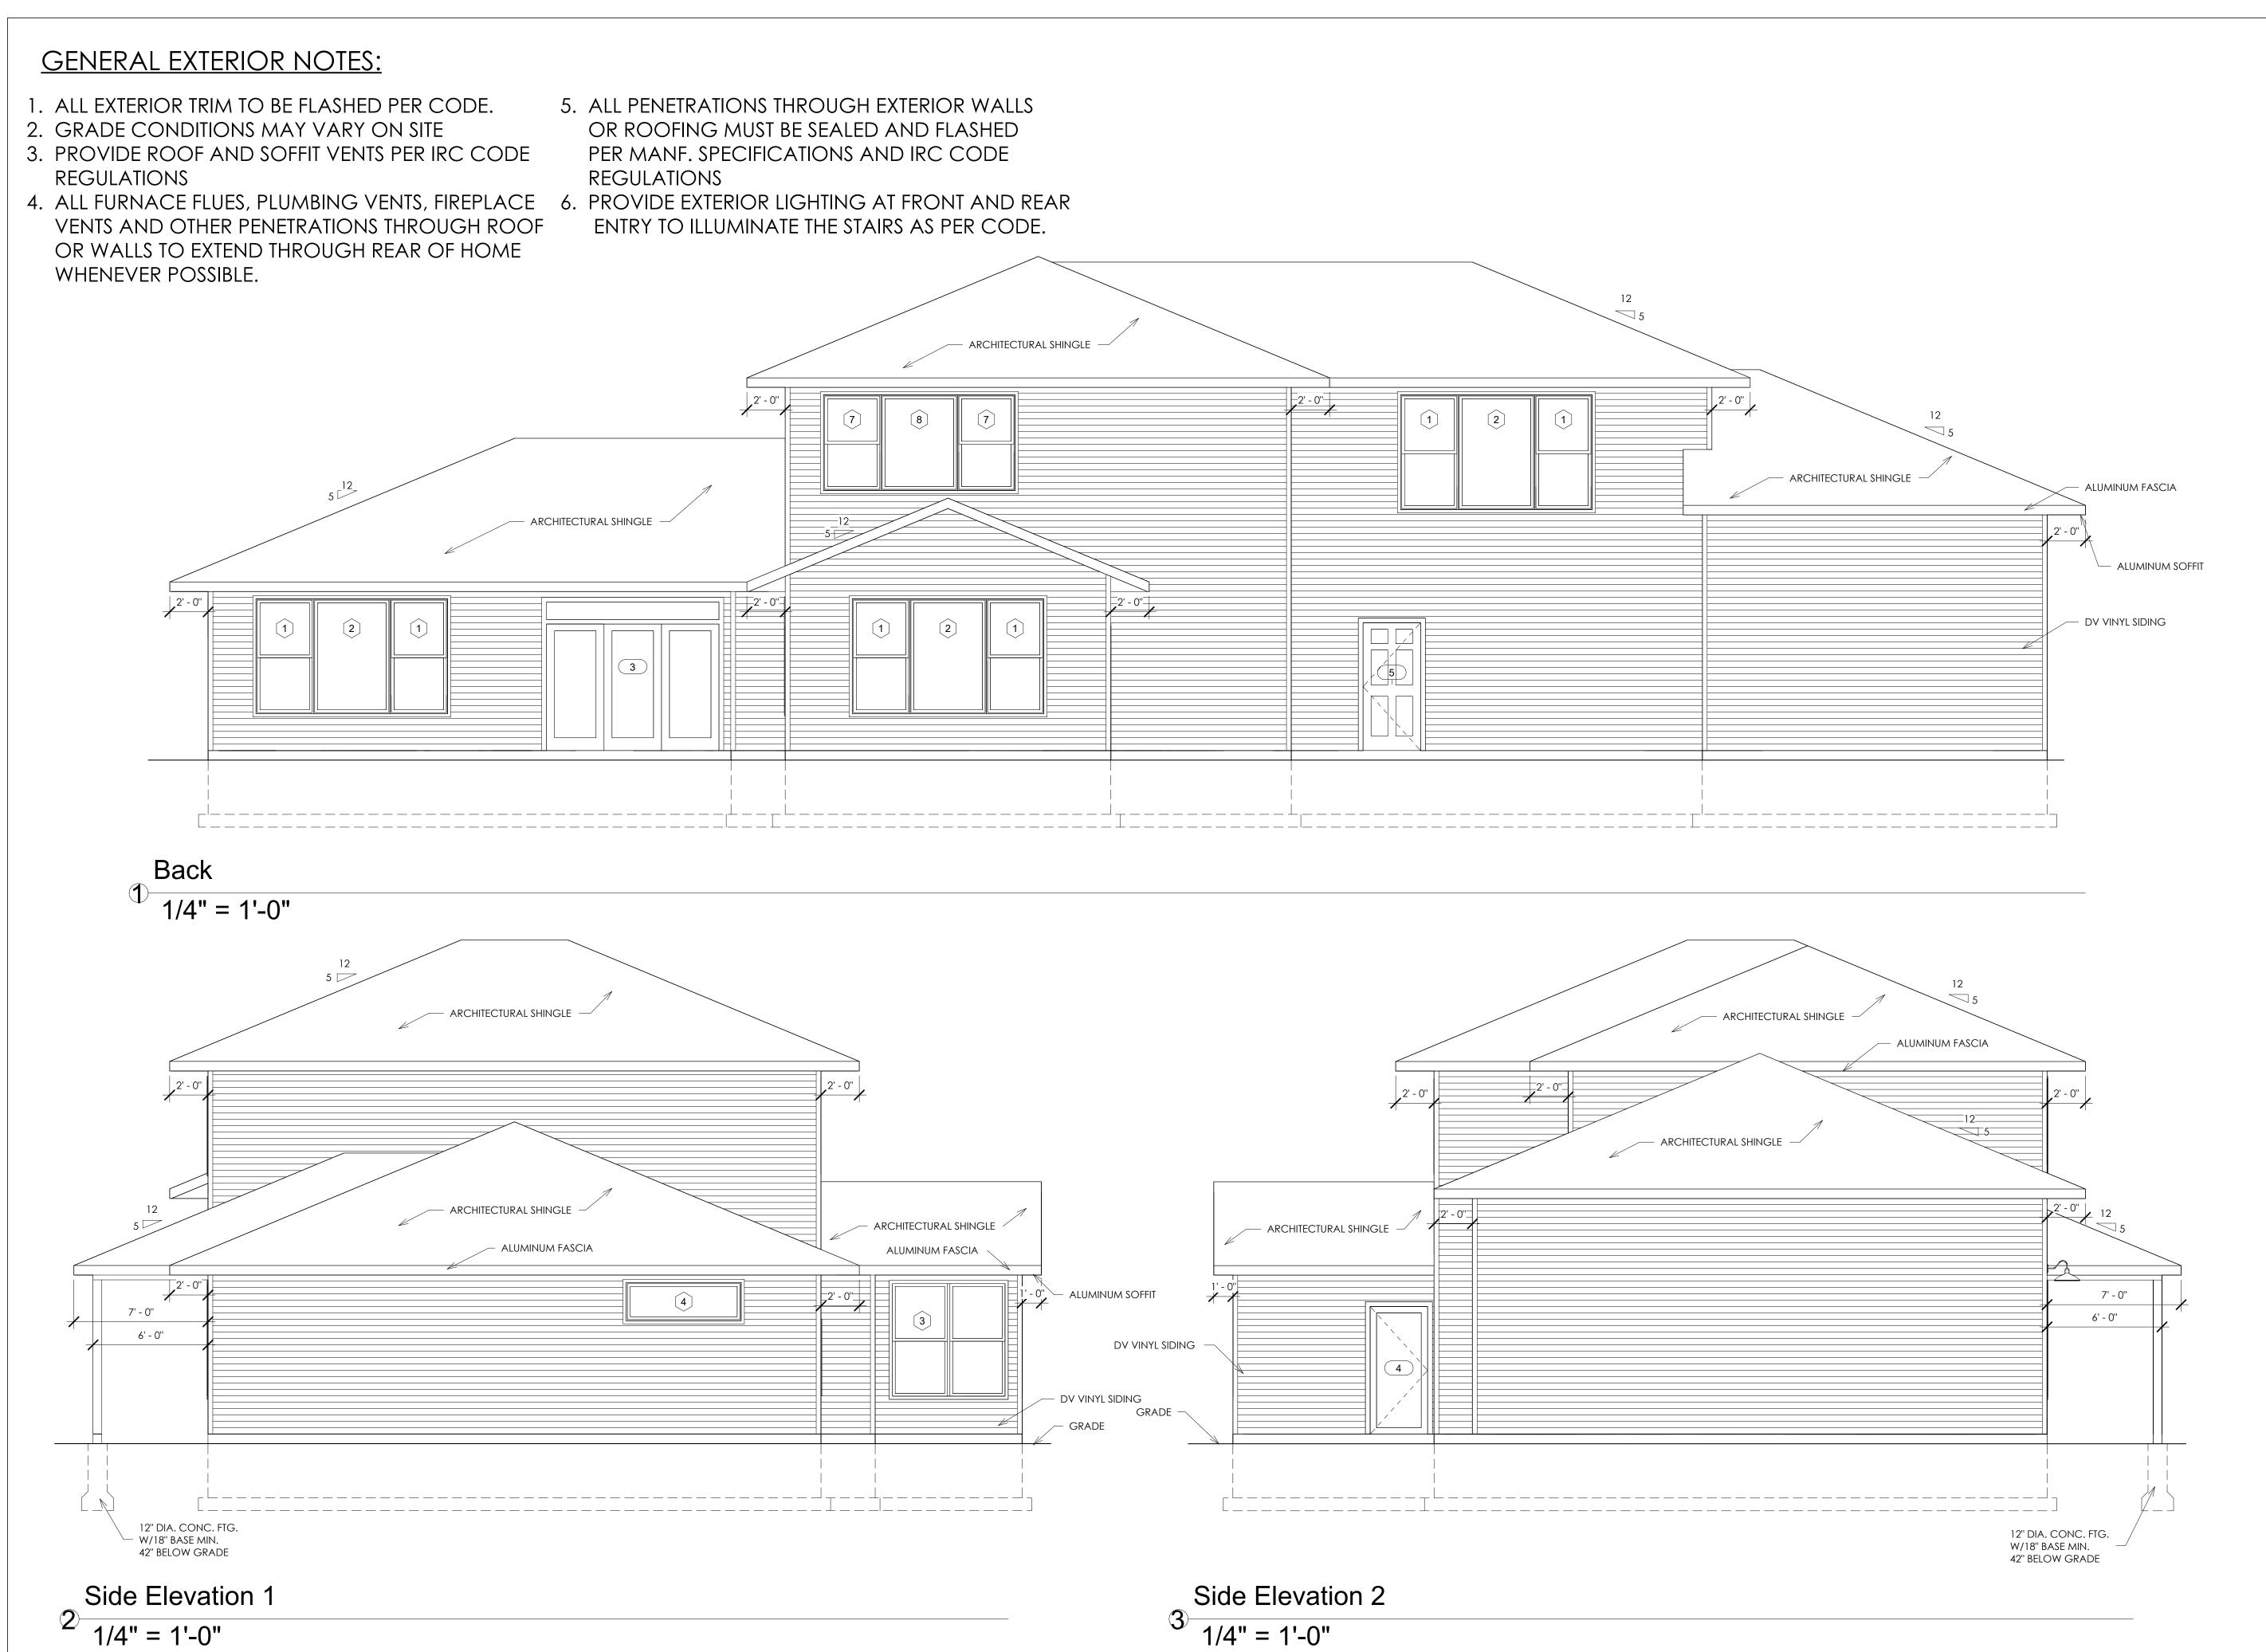



651-307-1640

NEWPORT



TWO STORY
SLAB ON GRADE
Elevations

Project number	Project Number
Date	08/23/2022
Drawn by	SWK
Checked by	Checker
F	12
Scale	1/4" = 1'-0"

GENERAL FOUNDATION NOTES:

- 1. FOUNDATIONS TO BE PER SITE SOIL CONDITION.
- 2. ALL REINFORCING IS TO BE INSTALLED PER IRC REGULATED STRUCTURAL DESIGN BY CONCRETE **TRADES**
- 3. PROVIDE 1/2" ANCHOR BOLTS EMBEDDED 8" MIN. SPACED PER CODE AND 12" MAX FROM EACH END OF SILLPLATE, MIN 2 PER SILL W/ 2" X 2" X/16" WASHER.

18' - 0''

4. SLOPE OF CONCRETE TO FLOOR DRAINS WITHIN 5' OF DRAINS

21' - 5 1/2"

5. ALL WOOD MATERIAL CONTACTING DIRECTLY TO CONCRETE MUST BE TREATED OR DESIGNED TO CONTACT CONCRETE.

CONCRETE NOTES:

17' - 0''


1. ALL CONCRETE FOOTINGS AND FOUNDATION SYSTEM ARE DESIGNED FOR A 2000 P. SF. SOIL 2. FOUNDATION WALLS SHALL BE FULL HEIGHT AT UNBALANCED FILL GREATER THAN 3/4" 3. 1/2" ANCHOR BOLTS EMBEDDED 7" MIN @ 4" O.C. MAX. 12" MIN FROM EACH END. MIN. OF 2 BOLTS IN EACH SILL PLATE W/2" X 2" X 3/16" WASHER 4. PAD FOOTING REINFORCEMENT IS TO BE LOCATED (3") FROM BOTTOM OF FOOTING TYP. (WHEN REQUIRED) 5. MIN 5000 PSI CONCRETE @ ALL FOOTINGS.

30' - 1 1/2"



651-307-1640



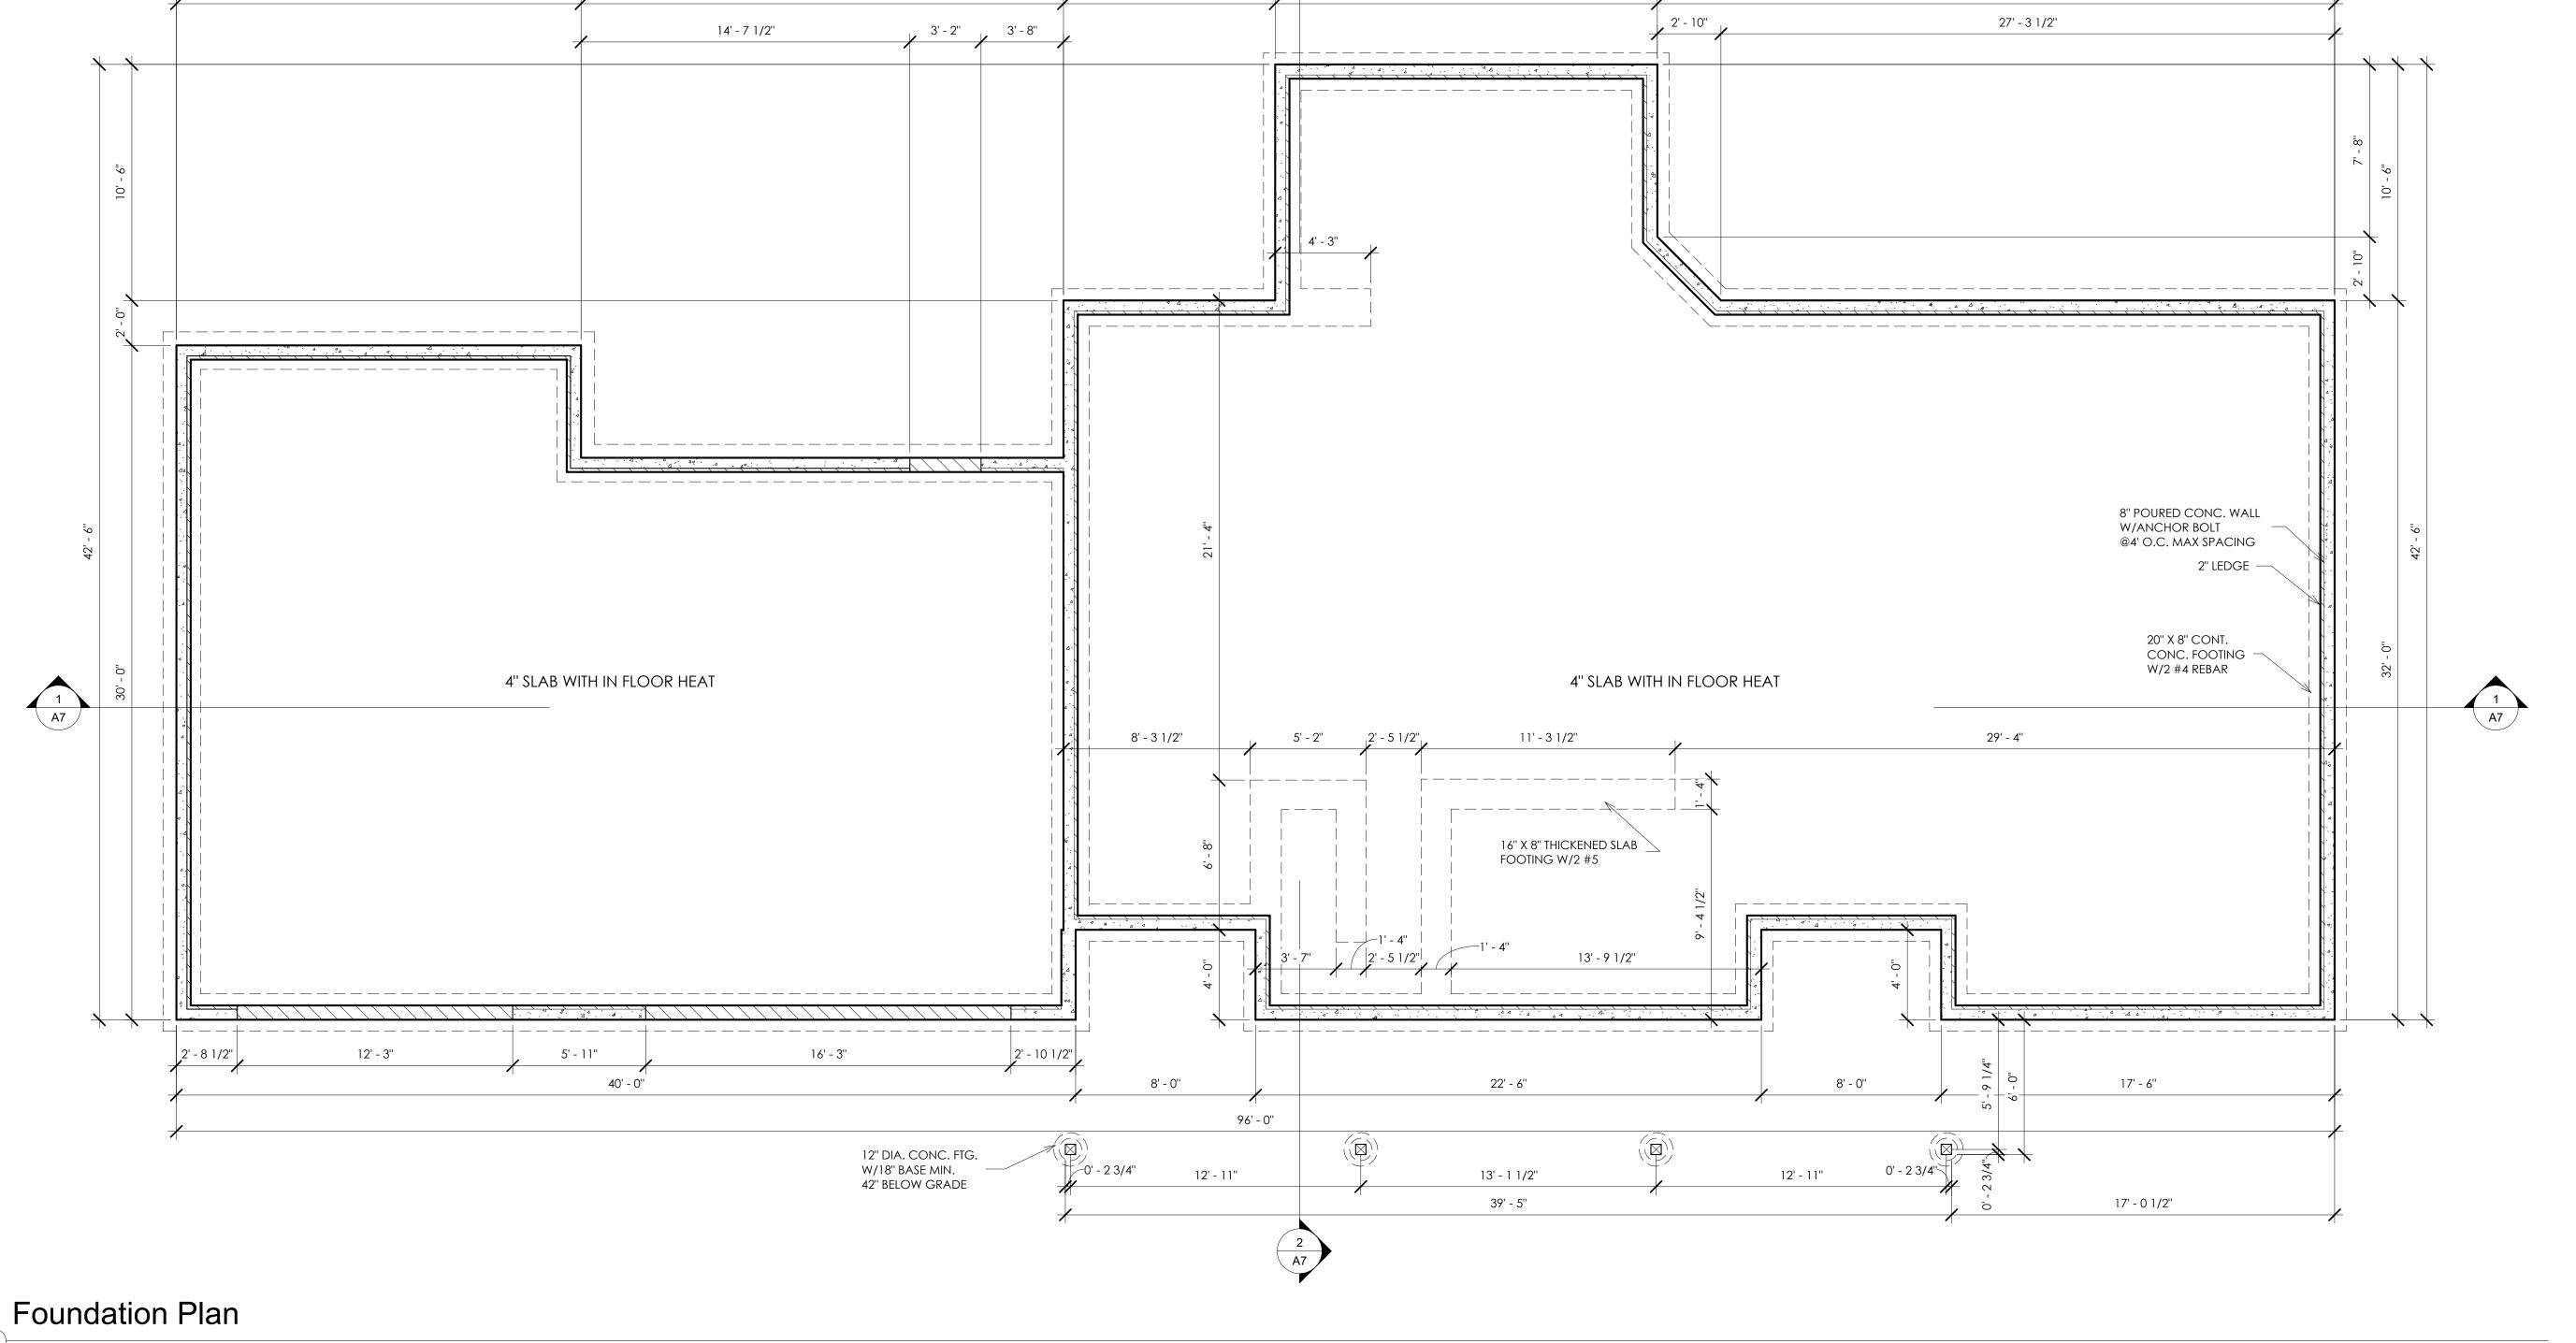

96' - 0''

9' - 5"

1/4" = 1'-0"

Project Number 08/23/2022 SWK Checker Checked by

Foundation

A3

1/4" = 1'-0"

GENERAL FRAMING NOTES:

- 1. ALL NON-BEARING FRAMING IS TO BE 16" O.C. UNLESS OTHERWISE NOTED.
- 2. ALL WALLS TO HAVE DOUBLE TOP PLATE UNLESS OTHERWISE NOTED.
- 3. ALL EXTERIOR WALLS ARE TO BE 2 X 6 WOOD STUDS WITH 7/16" OSB SHEATHING UNLESS OTHERWISE NOTED.
- 4. ALL INTERIOR WALLS ARE TO BE 2 X 4 WOOD STUDS UNLESS OTHERWISE NOTED.
- 5. ALL COLUMN SIZES ARE TO BE CONTINUED THROUGH FLOOR TRUSS SPACES WHEN SPANNING MORE

STRUCTURAL NOTES:

- 1. ALL HEADERS TO BE SUPPORTED BY A MIN. OF 1 TRIMMER (UNLESS OTHERWISE NOTED).
- 2. ALL TO HAVE AT LEAST (1) KING STUD (UNLESS NOTED)
- 3. ALL STUD CALLOUTS @ SIDES OF WINDOWS/DOORS ARE 9. FLOOR DECKING TO BE 3/4" SHEATHING, NAILED OR TRIMMERS, MIN. (1) KING STUDS @SAID LOCATIONS TO BE INCLUDED AS WELL.
- 4. BLOCKING @ ROOF & FLOOR PLAN PER TRUSS MANF.
- 5. POINT LOADS TO BE CARRIED THROUGH FLOOR AREAS AND DOWN TO FOUNDATION FOR SUPPORT.
- 6. ALL HANGERS & CONNECTIONS PER TRUSS MANF., SUPPLIERS & CONTRACTOR.
- 8. ROOF DECKING TO 1/2" NOMINAL (OF 15/32") OSB DECKING W/CLIPS, NAILED TO ROOF FRAMING W/MIN.. 8D COMMON NAILS, 6" O.C. @EDGES/12"O.C. @ FIELD.
- SCREWED TO FLOOR SYSTEM PER CODE W/ADHESIVE PER SPEC. (OR) MIN. 6D COMMON NAILS 6" O.C. @EDGES/12" O.C. @FIELD (CODE MINIMUM.




651-307-1640



SLAB ON GRADE Main Level

Project Number 08/23/2022 SWK Drawn by Checked by Checker

A4 1/4" = 1'-0"

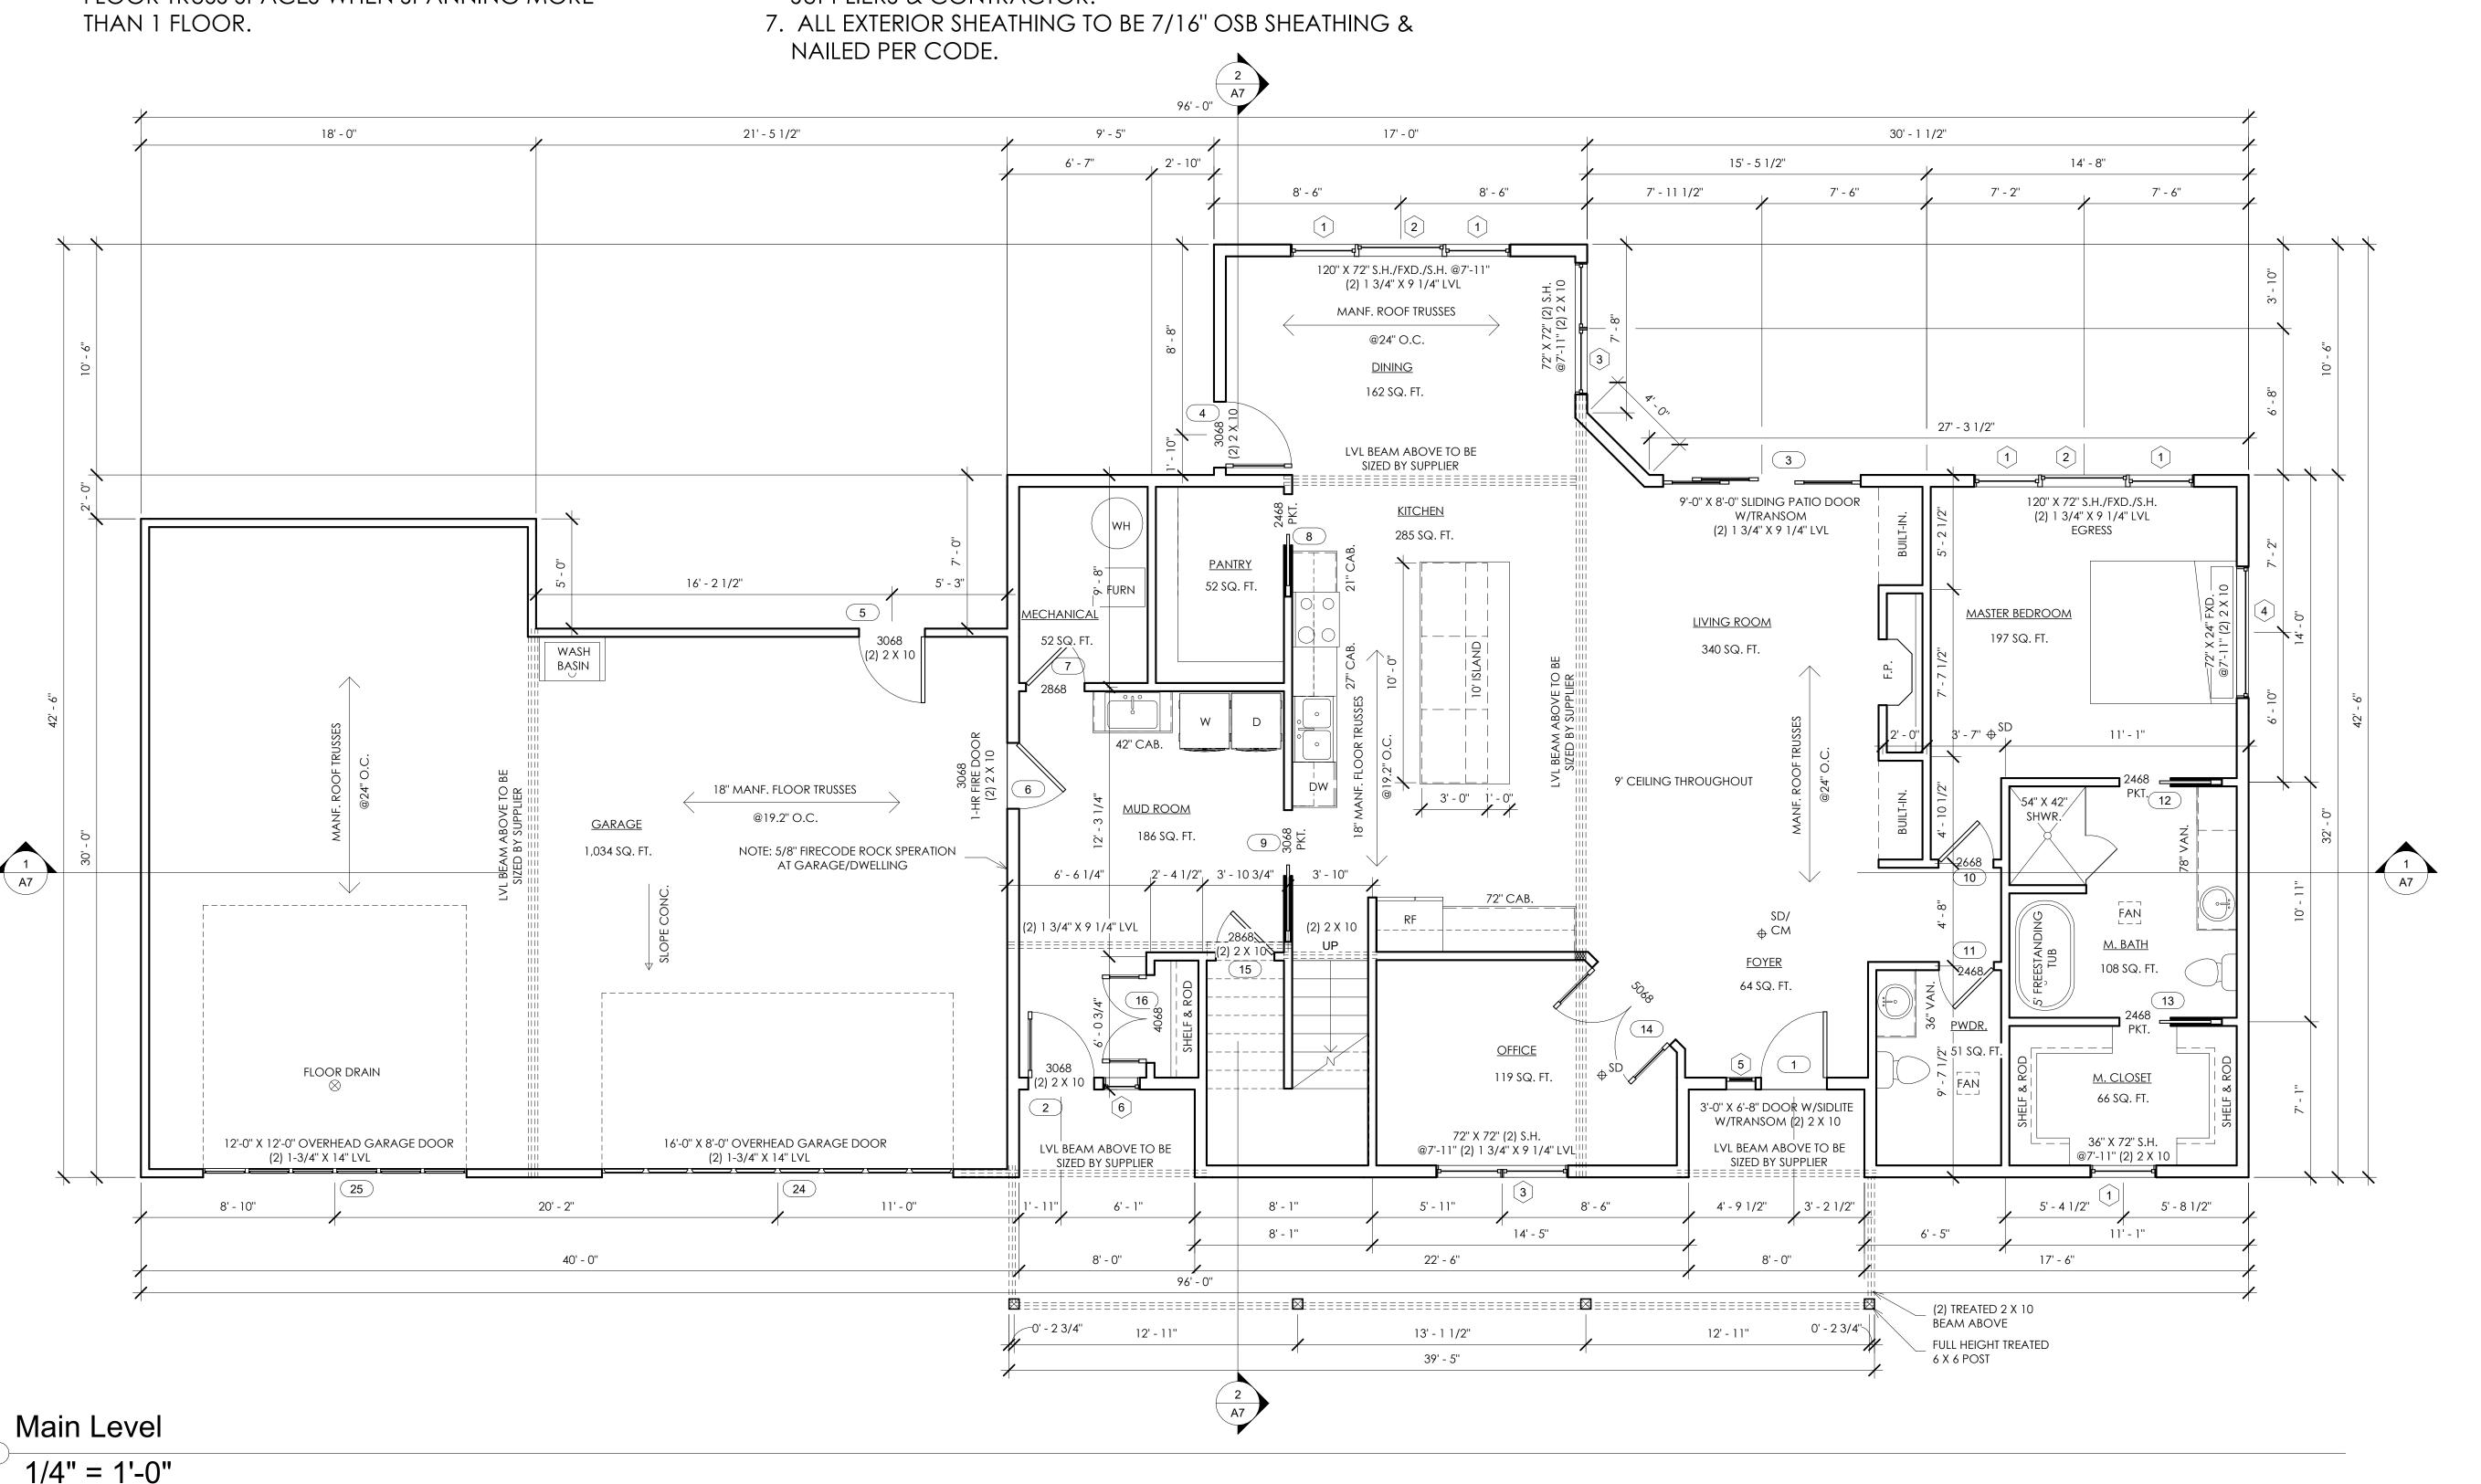

FRAMING NOTES:

1. ALL EXTERIOR WALLS TO BE 16" O.C. WITH A DOUBLE TOP PLATE UNLESS OTHERWISE NOTED 2. WALL FRAMING SHALL BE S.P.F. STUD GRADE OR BETTER UNLESS NOTED OTHERWISE (U.N.O). 3. ALL HEADERS SHALL BE PER PLAN. 4. ALL EXTERIOR HEADERS SHALL HAVE (1) 2X6 BEARING STUD & (1) 2X6 FULL HEIGHT KING STUD ON EACH SIDE U.N.O. (REVIEW PLANS) 5. ALL INTERNAL HEADERS & BEAMS SHALL HAVE (1) 2X6 OR (1) 2X4 BEARING STUD ON EACH SIDE. 6. EXTERIOR SHEATHING SHALL BE 7/16" OSB WALL SHEATHING. ALL FLOOR AND CEILING SYSTEMS TO BE CHECKED AND DESIGNED BY THE DESIGNATED MANF. FLOOR PLANS TO BE ON SITE. 7. HEADER SIZES ARE TO BE USED PER PLAN AND DEVIATION FROM ANY SIZE MUST BE APPROVED BY DESIGNERS.

8. PRESSURE TREATED WOOD IS TO BE USED WHERE WOOD IS IN CONTACT WITH CONCRETE AND AT 2X6 MUD SILL. TREATED MEMBERS TO BE S.Y.P. #2 OR BETTER.

9. FOR OPENINGS IN EXTERIOR WALLS (OR WALLS W/ LATERAL LOADING:

> A. 0'-0" - 4'-0" = 1 JACK STUD B. 4-0'' - 8'-0'' = 2 JACK STUDS C. 8'-0" - 12'-0" = 3 JACK STUDS D. GREATER THAN 12' = CONSULT ENG.

10. POSTS CALLED OUT ARE NUMBER OF KING STUDS REQUIRED PER SIDE OF OPENING.

INSULATION:

1. ALL EXTERIOR WALL TO HAVE A MIN. RATING OF R-21


2. ALL ATTIC SPACES ARE TO HAVE A MIN. RATING OF R-49 3. ALL FLOOR SPACES OVER UNCONDITIONED SPACE OR CANTILEVERED ARE TO BE INSULATED TO MIN R-30.

SHEETROCK/GYPSUM BOARD

1. ALL CEILINGS ARE TO HAVE 1/2" NON -SAG GYPSUM BOARD UNLESS OTHERWISE NOTED. 2. ALL WALLS ARE TO HAVE 1/2" GYPSUM BOARD UNLESS OTHERWISE NOTED.

MECHANICAL & ELECTRICAL:

1. ALL ELECTRICAL AND MECHANICAL EQUIPMENT TO BE VERIFIED AND INSTALLED PER CODE BY APPROVED TRADES AND INSTALLERS. 2. HVAC CONTRACTOR TO VERIFY LAYOUT FOR DUCT-RUNS BEFORE INSTALLATION. IF MODIFICATION IS REQUIRED, REPORT INFORMATION/CHANGES TO CONTRACTOR.

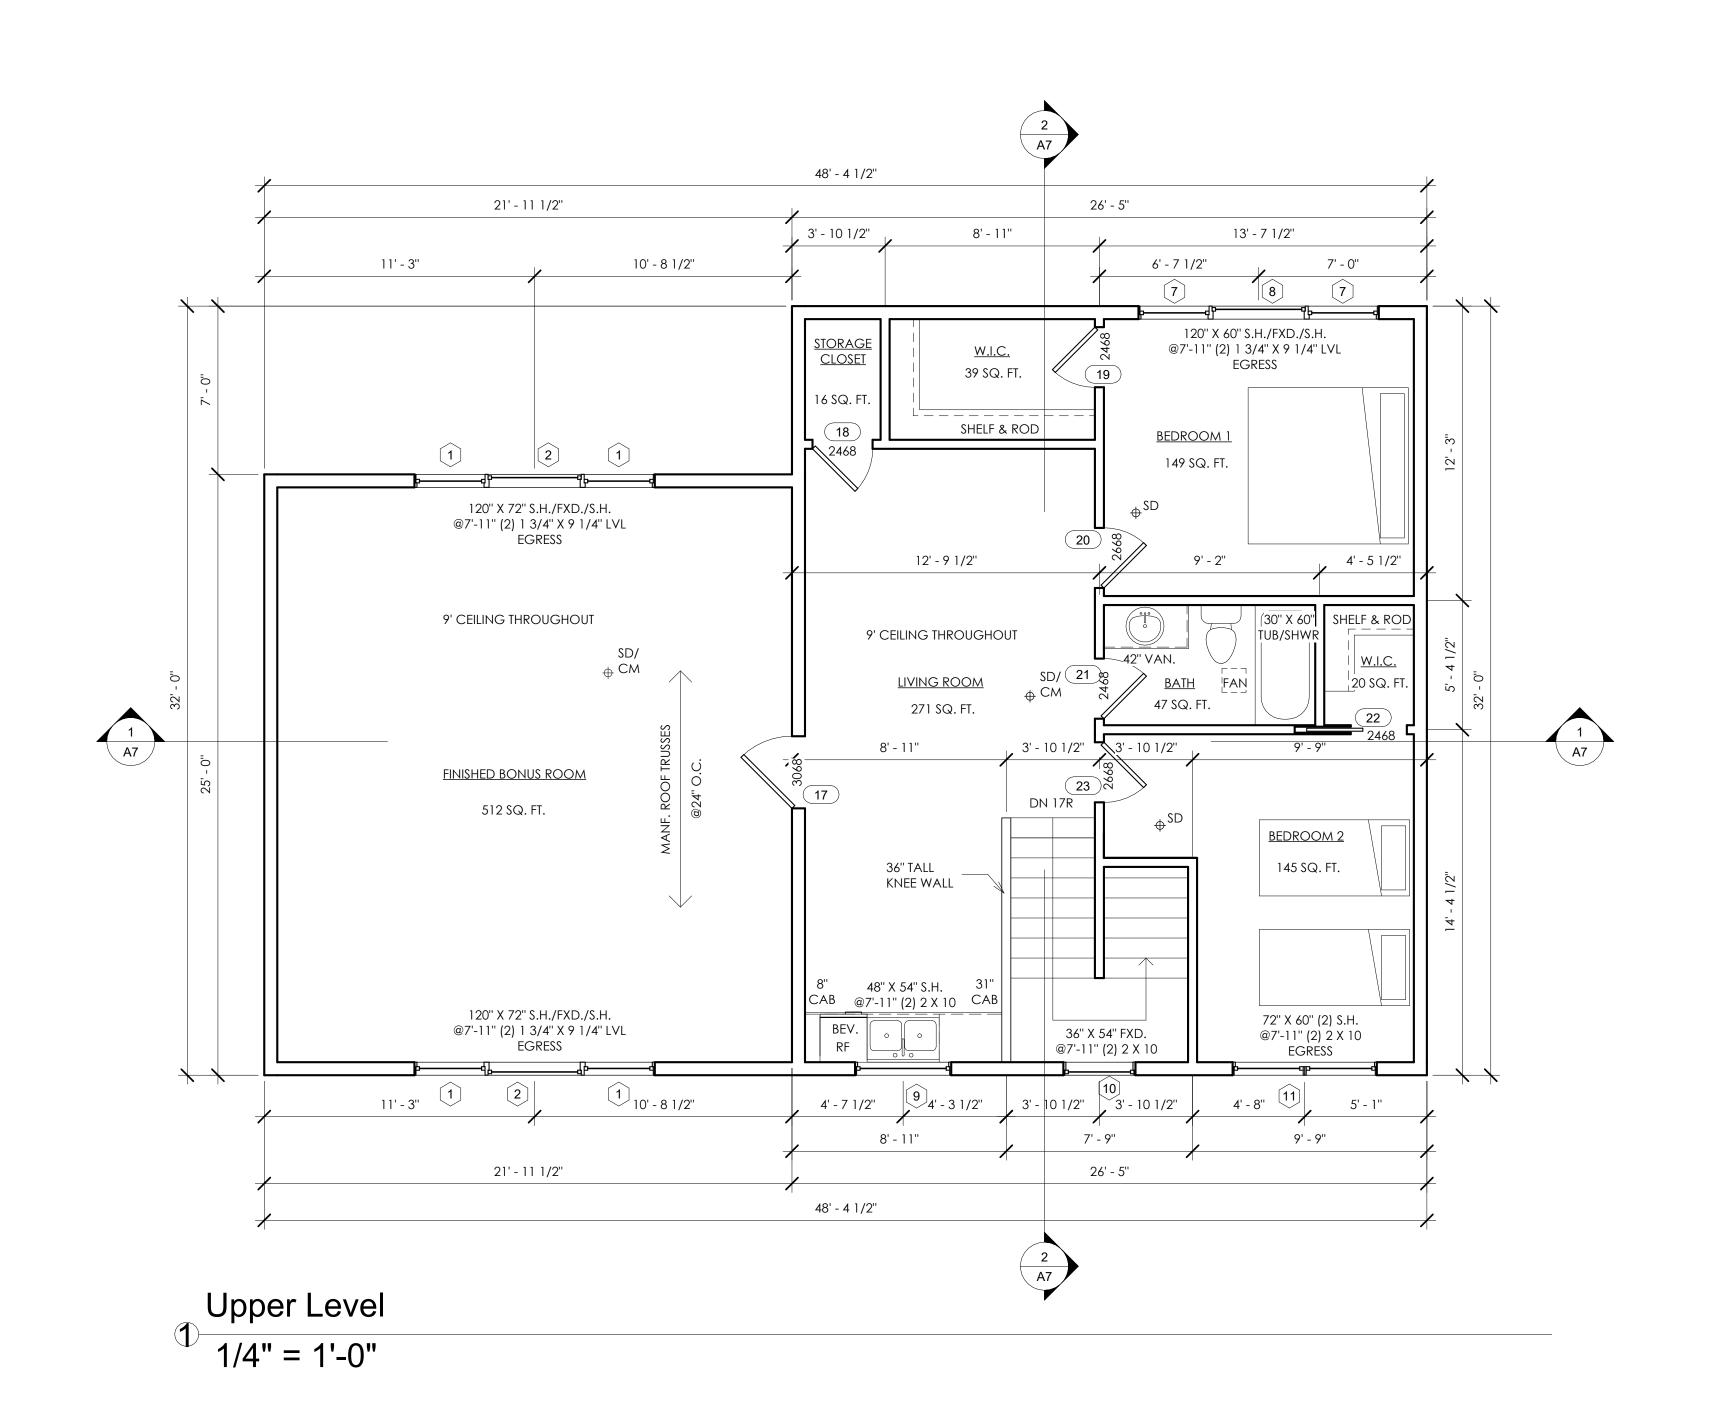



651-307-1640

No.	Description	Date


IWOSIORY **SLAB ON GRADE**

Upper Level Plan

Project Number 08/23/2022 SWK Checked by Checker **A5**


Scale

1/4" = 1'-0"

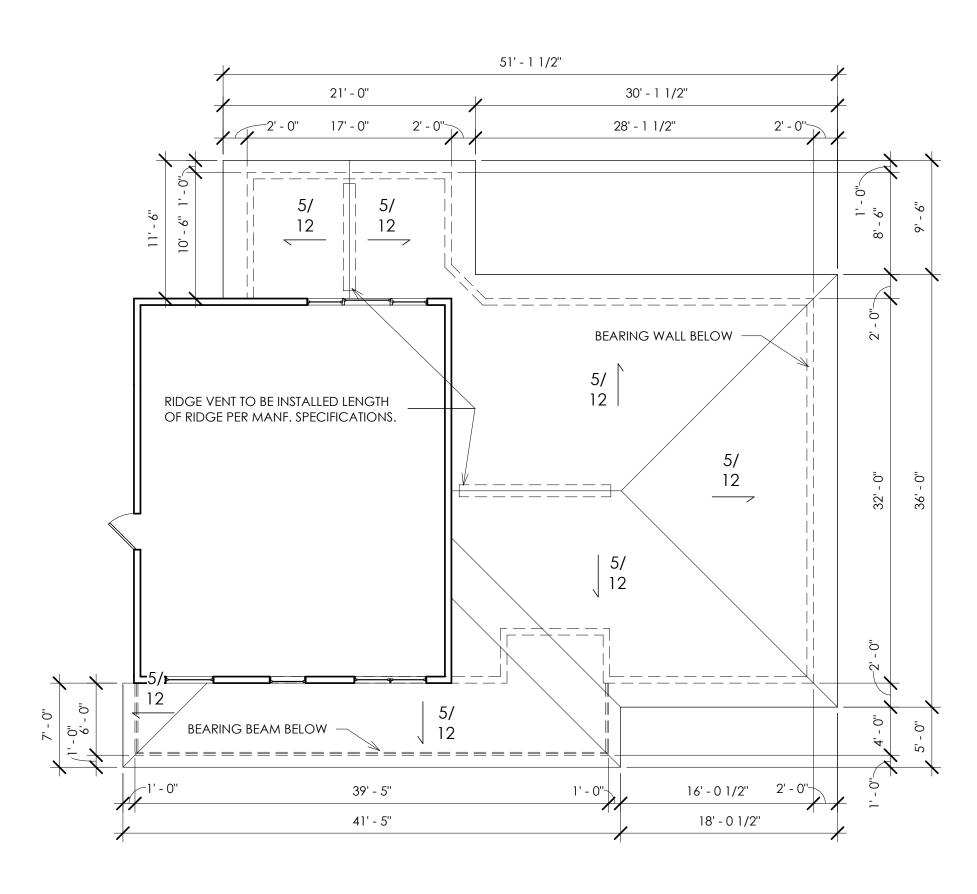

Main Level Roof Plan

1/8" = 1'-0"

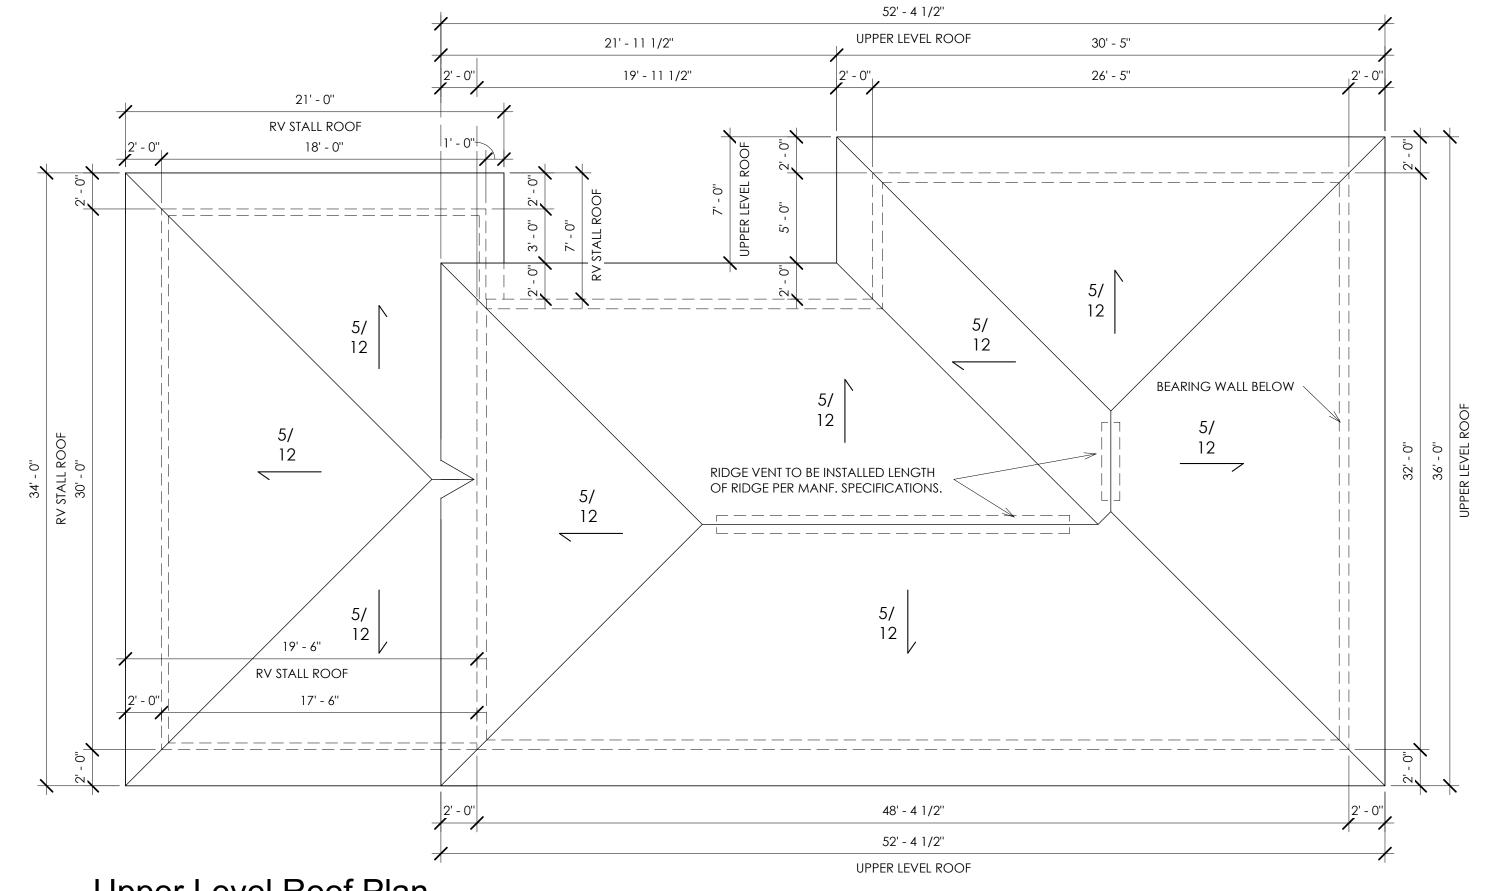

Upper Level Roof Plan
2 3/16" = 1'-0"



651-307-1640

NEWPORT

No.	Description	Date

TWO STORY
SLAB ON GRADE
Roof Plan

Project number

Date

Drawn by

Checked by

Project Number

08/23/2022

Drawn by

SWK


Checked by

Checker

A6

As indicated

ated

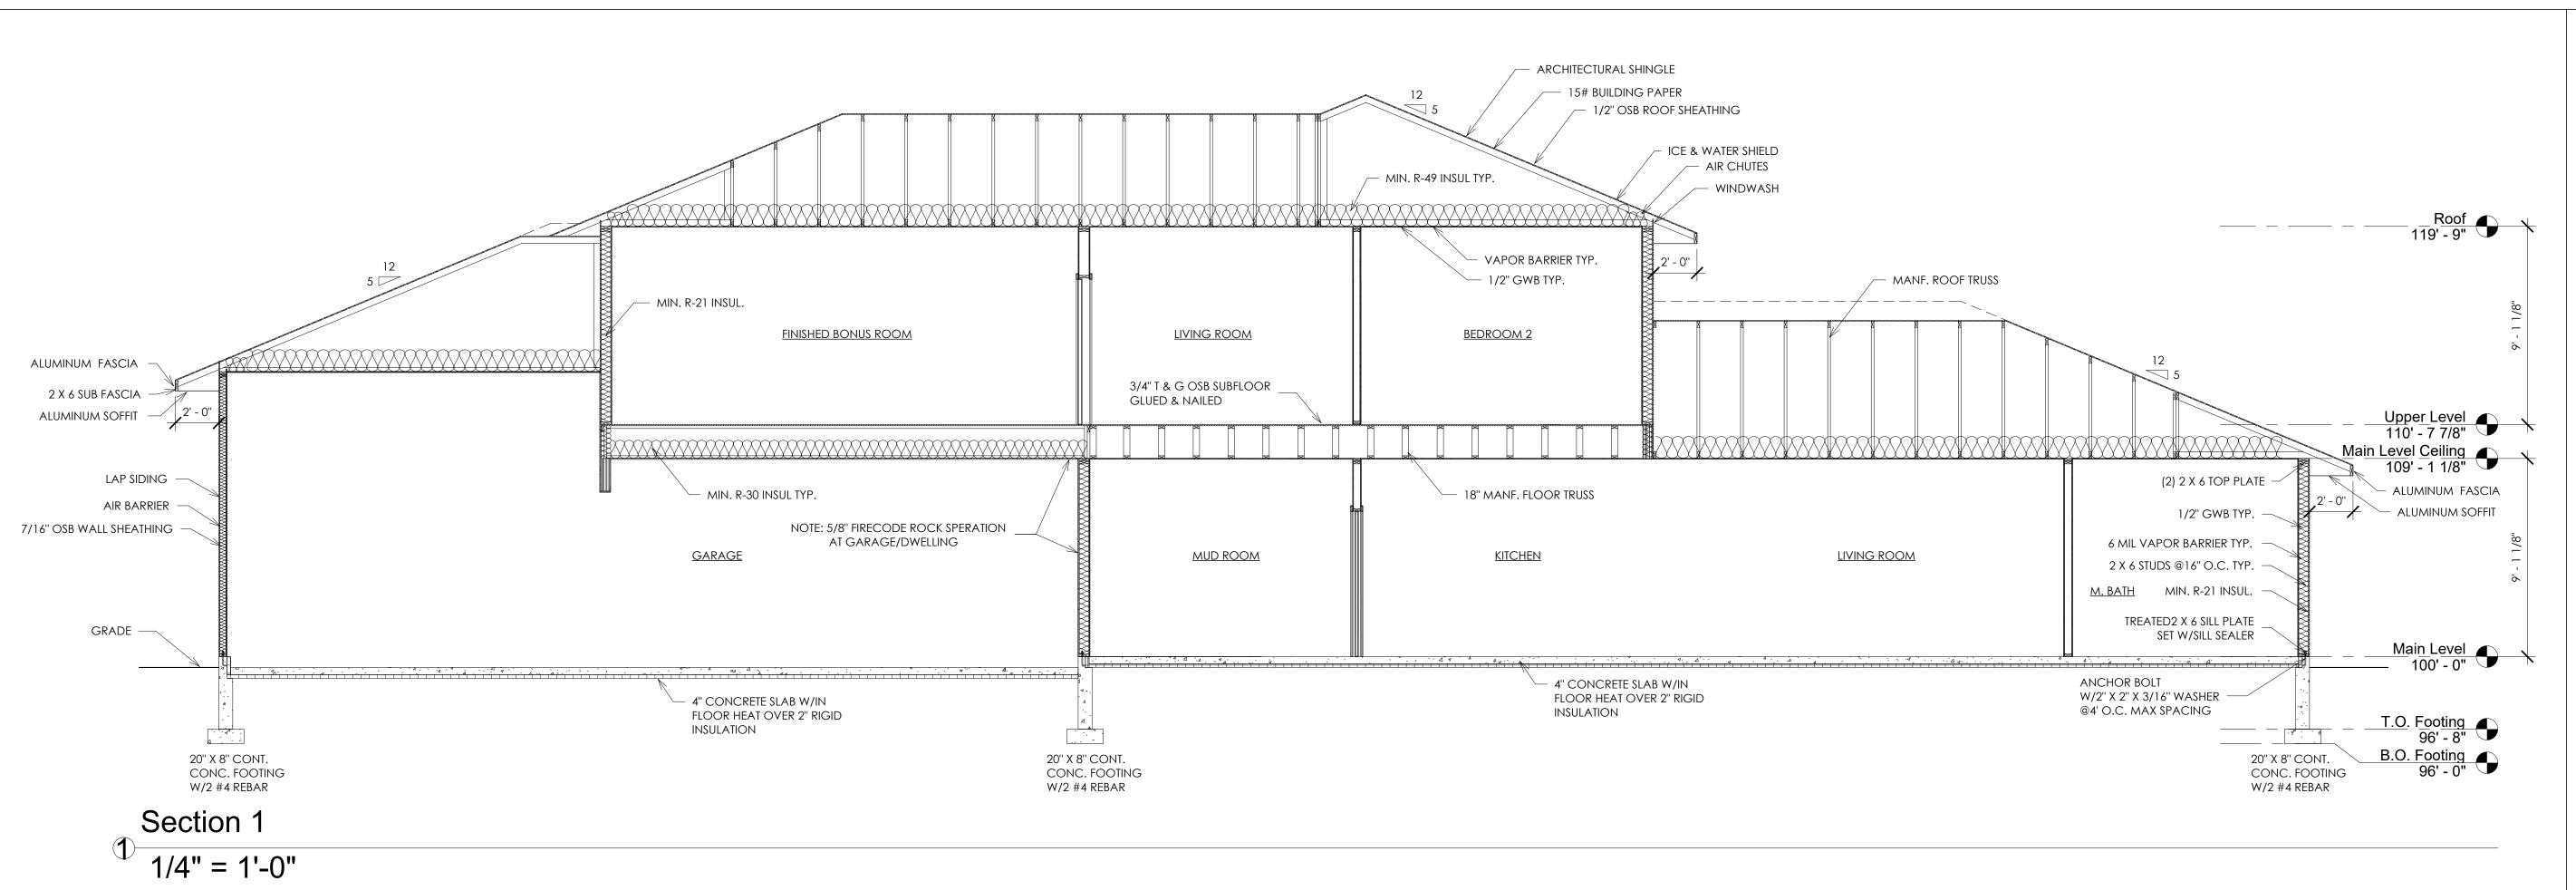



651-307-1640



SLAB ON GRADE **Building Sections**

Project Number Project number 08/23/2022 SWK Drawn by Checker Checked by **A7** Scale As indicated

1/2" OSB ROOF SHEATHING MANF. ROOF TRUSS ICE & WATER SHIELD AIR CHUTES MIN. R-49 INSUL TYP. WINDWASH ALUMINUM FASCIA TREATED 2 X 6 SILL PLATE SET W/SILL SEALER 2 X 6 SUB FASCIA VAPOR BARRIER TYP. **ALUMINUM SOFFIT** - 1/2" GWB TYP. LAP SIDING -4" CONC. SLAB W/IN FLOOR HEAT AIR BARRIER 7/16" OSB WALL SHEATHING LIVING ROOM ANCHOR BOLT W/2" X 2" X 3/16" WASHER @4' O.C. MAX SPACING MIN. R-21 INSUL. 3/4" T & G OSB SUBFLOOR GLUED & NAILED MIN. R-49 INSUL TYP. 2" R10 RIGID 18" MANF. FLOOR TRUSS Main Level Ceiling 109' - 1 1/8" INSULATION 1' - 0" - (2) 2 X 6 TOP PLATE (2) TREATED 8" POURED CONC. FOUNDATION WALL 2 X 10 BEAM - 1/2" GWB TYP. 6' - 0'' - 6 MIL VAPOR BARRIER TYP. <u>PANTRY</u> MUD ROOM 2 X 6 STUDS @16" O.C. TYP. 12" DIA. CONC. FTG. W/18" BASE MIN. TREATED2 X 6 SILL PLATE 42" BELOW GRADE SET W/SILL SEALER Main <u>Level</u> 100' - 0" 8" POURED CONC. WALL - GRADE - 4" CONCRETE SLAB W/IN FLOOR HEAT OVER 2" RIGID 16" X 8" CONT. CONC. FOOTING W/2 #4 REBAR ANCHOR BOLT
- W/2" X 2" X 3/16" WASHER
@4' O.C. MAX SPACING 20" X 8" CONT. CONC. FOOTING W/2 #4 REBAR INSULATION T.O. Footing 96' - 8" - 20" X 8" CONT. CONC. FOOTING W/2 #4 REBAR 20 X 8" CONT. CONC. FOOTING W/2 #4 REBAR 20" X 8" CONT. CONC. FOOTING W/2 #4 REBAR B.O. Footing 96' - 0" Foundation Detail Section 2 1/4" = 1'-0" 1" = 1'-0"

ARCHITECTURAL SHINGLE

15# BUILDING PAPER