

DEMOLITION NOTES:

- TANKS AND TANK WALLS NOTED FOR DEMOLITION SHALL HAVE CONCRETE WALLS REMOVED TO A DEPTH OR NO LESS THAN 3 FEET BELOW FINISH GRADE. REBAR AND STEEL SHALL BE CUT FLUSH TO CONCRETE SURFACES.
- INTERIOR OF ALL TANKS NOTED FOR DEMOLITION / WALL REMOVAL SHALL BE PERFORATED IN A 10' X 10' GRID.
- ALL TANKS SHALL BE EMPTIED AND BACK FILLED PER SPECIFICATIONS.

CONSTRUCTION NOTES:


- PROVIDE 4 INCHES OF TOPSOIL OVER DISTURBED SURFACE. SEED AND MULCH SOIL IN ACCORDANCE WITH SPECIFICATIONS.

GENERAL NOTES:

- THESE PLANS ARE BASED ON A TOPOGRAPHIC SURVEY CONDUCTED WITH A THREE SECOND TOTAL STATION ON 7/8/19 & 7/9/19 BY OTTER CREEK ENGINEERING, INC.
- IN THE PREPARATION OF THESE PLANS, DATA FROM THE FOLLOWING SOURCES WAS INCORPORATED:
 - PLANS TITLED "TOWN OF MIDDLEBURY, SEYMOUR STREET WATER REPLACEMENT, MIDDLEBURY, VERMONT", PREPARED BY OTTER CREEK ENGINEERING, INC., MIDDLEBURY, VERMONT, DATED 12/17/03 RECORD DRAWING.
 - PLAN TITLED "DECOMMISSIONING PLAN EXISTING WASTEWATER TREATMENT FACILITY, MIDDLEBURY, VERMONT", PREPARED BY DUFRESNE-HENRY, INC. CONSULTING ENGINEERS, MANCHESTER, NH, DATED JUNE 26, 1998, RECORD DRAWING.
- VERTICAL DATUM IS NAVD 88.
- COORDINATE SYSTEM IS VERMONT STATE PLANE NAD 83.
- FOR CLARITY, TEXT DENOTING EXISTING ITEMS IS SHOWN IN LOWER CASE, AND TEXT DENOTING PROPOSED ITEMS IS UPPERCASE AND BOLD.
- REFER TO LEGEND LOCATED ON THIS SHEET FOR SYMBOL DESIGNATIONS.
- ALL UNDERGROUND UTILITIES ARE SHOWN AS APPROXIMATE LOCATIONS.
- FOR CLARITY, OVERHEAD LINES ARE NOT SHOWN.
- THIS IS NOT A BOUNDARY SURVEY.
- CONTRACT DOCUMENTS AND TECHNICAL SPECIFICATIONS ACCOMPANY THESE PLANS AND ARE ESSENTIAL FOR CONSTRUCTION OF THIS PROJECT.

LEGEND


	boundary line/r.o.w.
	easement
	road/parking/drive (paved)
	road/parking/drive (gravel)
	tree line/hedge row
	1 foot contour
	5 foot contour
	stone wall
	underground electric
	overhead utility
	underground telephone
	ditch line/drainage
	storm drain
	water main
	sanitary sewer
	sewer force main
	liquid propane
	signs
	light pole
	utility pole
	guy
	gate valve
	curb stop
	hydrant
	iron pipe found
	catch basin
	sewer manhole
	storm drain manhole
	deciduous tree
	coniferous tree
	shrub, bush
	stump
	well
	monitoring well
	traverse station
	temporary benchmark
	FINISH GRADE
	STORM DRAIN
	CATCH BASIN
	WATER MAIN
	WATER SERVICE
	HYDRANT ASSEMBLY
	GATE VALVE
	REDUCER
	CURB STOP
	SANITARY SEWER
	SEWER MANHOLE

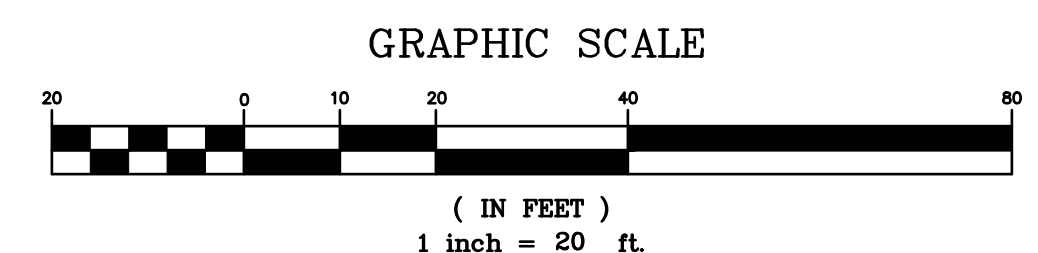

NOTE: TEXT DENOTING EXISTING ITEMS IS SHOWN IN LOWER CASE, AND TEXT DENOTING PROPOSED ITEMS IS UPPERCASE AND BOLD.

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STAMP AND SIGNATURE:
 DESIGN ENGINEER:
 THESE DRAWINGS SHALL NOT BE ALTERED IN ANY WAY WITHOUT THE WRITTEN APPROVAL OF THE ENGINEER. ANY REVISIONS SHALL BE MADE BY THE ENGINEER AND NOTED IN THE REVISION BLOCK. © 2019
 OTTER CREEK ENGINEERING, INC.

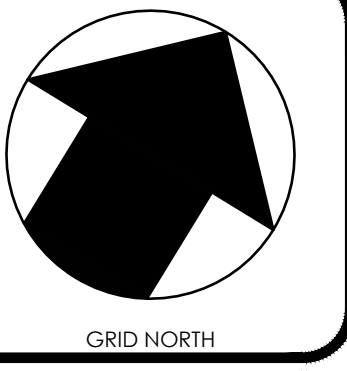

**TOWN OF MIDDLEBURY
 POLICE DEPARTMENT
 WATER AND SITE IMPROVEMENTS
 MIDDLEBURY, VERMONT**

REVIEW	
DATE ISSUED:	9/11/19
REVISIONS:	
DRAWN BY:	JL
CHECKED BY:	BFR
SCALE:	1"=20'
PROJECT NO.:	001.051
CADD FILE:	001-051
TITLE: SITE PLAN	
DRAWING NO. C-1	