

- 1958 1975








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FLOOR PLAN LEGEND

| WALL TO BE REMOVED                  |
|-------------------------------------|
| EXISTING STUD WALL                  |
| EXISTING BRICK WALL                 |
| EXISTING STRUCTAL CLAY TILE         |
| EXISTING CMU WALL                   |
| <br>EXISTING CONCRETE WALL          |
| NEW STUD WALL                       |
| NEW PARTIAL HEIGHT STUD WALL        |
| <br>NEW STUD WALL WITH HIGH WINDOWS |
|                                     |

|   | GOLDSTONE ARCHITECTURE<br>150 DEPOT STREET<br>P.O. BOX 139<br>BENNINGTON, VERMONT 05201   |
|---|---|
|   | GOLDSTONE<br>ARCHITECTURE   |
|   | CONSULTANTS   |
|   | MSK Engineering & Design, INC.<br>P.O. Box 139, 150 Depot Street<br>Bennington, VT 05201<br>PH: (802) 447-1402 FAX: (802) 445-1291                                    |
|   | SB Engineering, PLLC<br>900 Rt. 149<br>Clifton Park, NY 12065<br>PH: (518) 724-0733   |
|   | VermontMassachusetts208 Flynn Avenue #2J32 Masonic St., Unit EBurlington, VT 05401Northampton, MA 01060(802) 655-7528(413) 776-9580Fax (802) 655-7628Inconsulting.com |
|   | KEY PLAN  |
|   | OLD BENN HIGH<br>RE-DEVELOPMENT<br>PROJECT<br>HALE RESOURCES  |
|   | 650 MAIN ST.<br>BENNINGTON, VT.<br>05201  |
|   | DESIGN DEVELOPMENT     MARK   DATE   DESCRIPTION  |
|   |   |
|   |   |
| BUILDING OCCUPANTS  |   |
| COMMON / CIRCULATION<br>DAYCARE<br>HOUSING  | PRELIMINARY   |
| FLOOR PLAN LEGEND   |   |
| EXISTING STUD WALL   EXISTING BRICK WALL   EXISTING STRUCTAL CLAY TILE  | PROJECT NUMBER:DATE:03/31/23DRAWN BY:TS/EB  |
| EXISTING CMU WALL   EXISTING CONCRETE WALL   NEW STUD WALL   NEW PARTIAL HEIGHT STUD WALL   NEW STUD WALL WITH HIGH WINDOWS | CHECKED BY: JG/JB<br>OVERALL PROPOSED<br>BASEMENT PLAN  |
| 0 16' 32' 48'<br>SCALE: 1/16" = 1'-0"   | G100.1  |




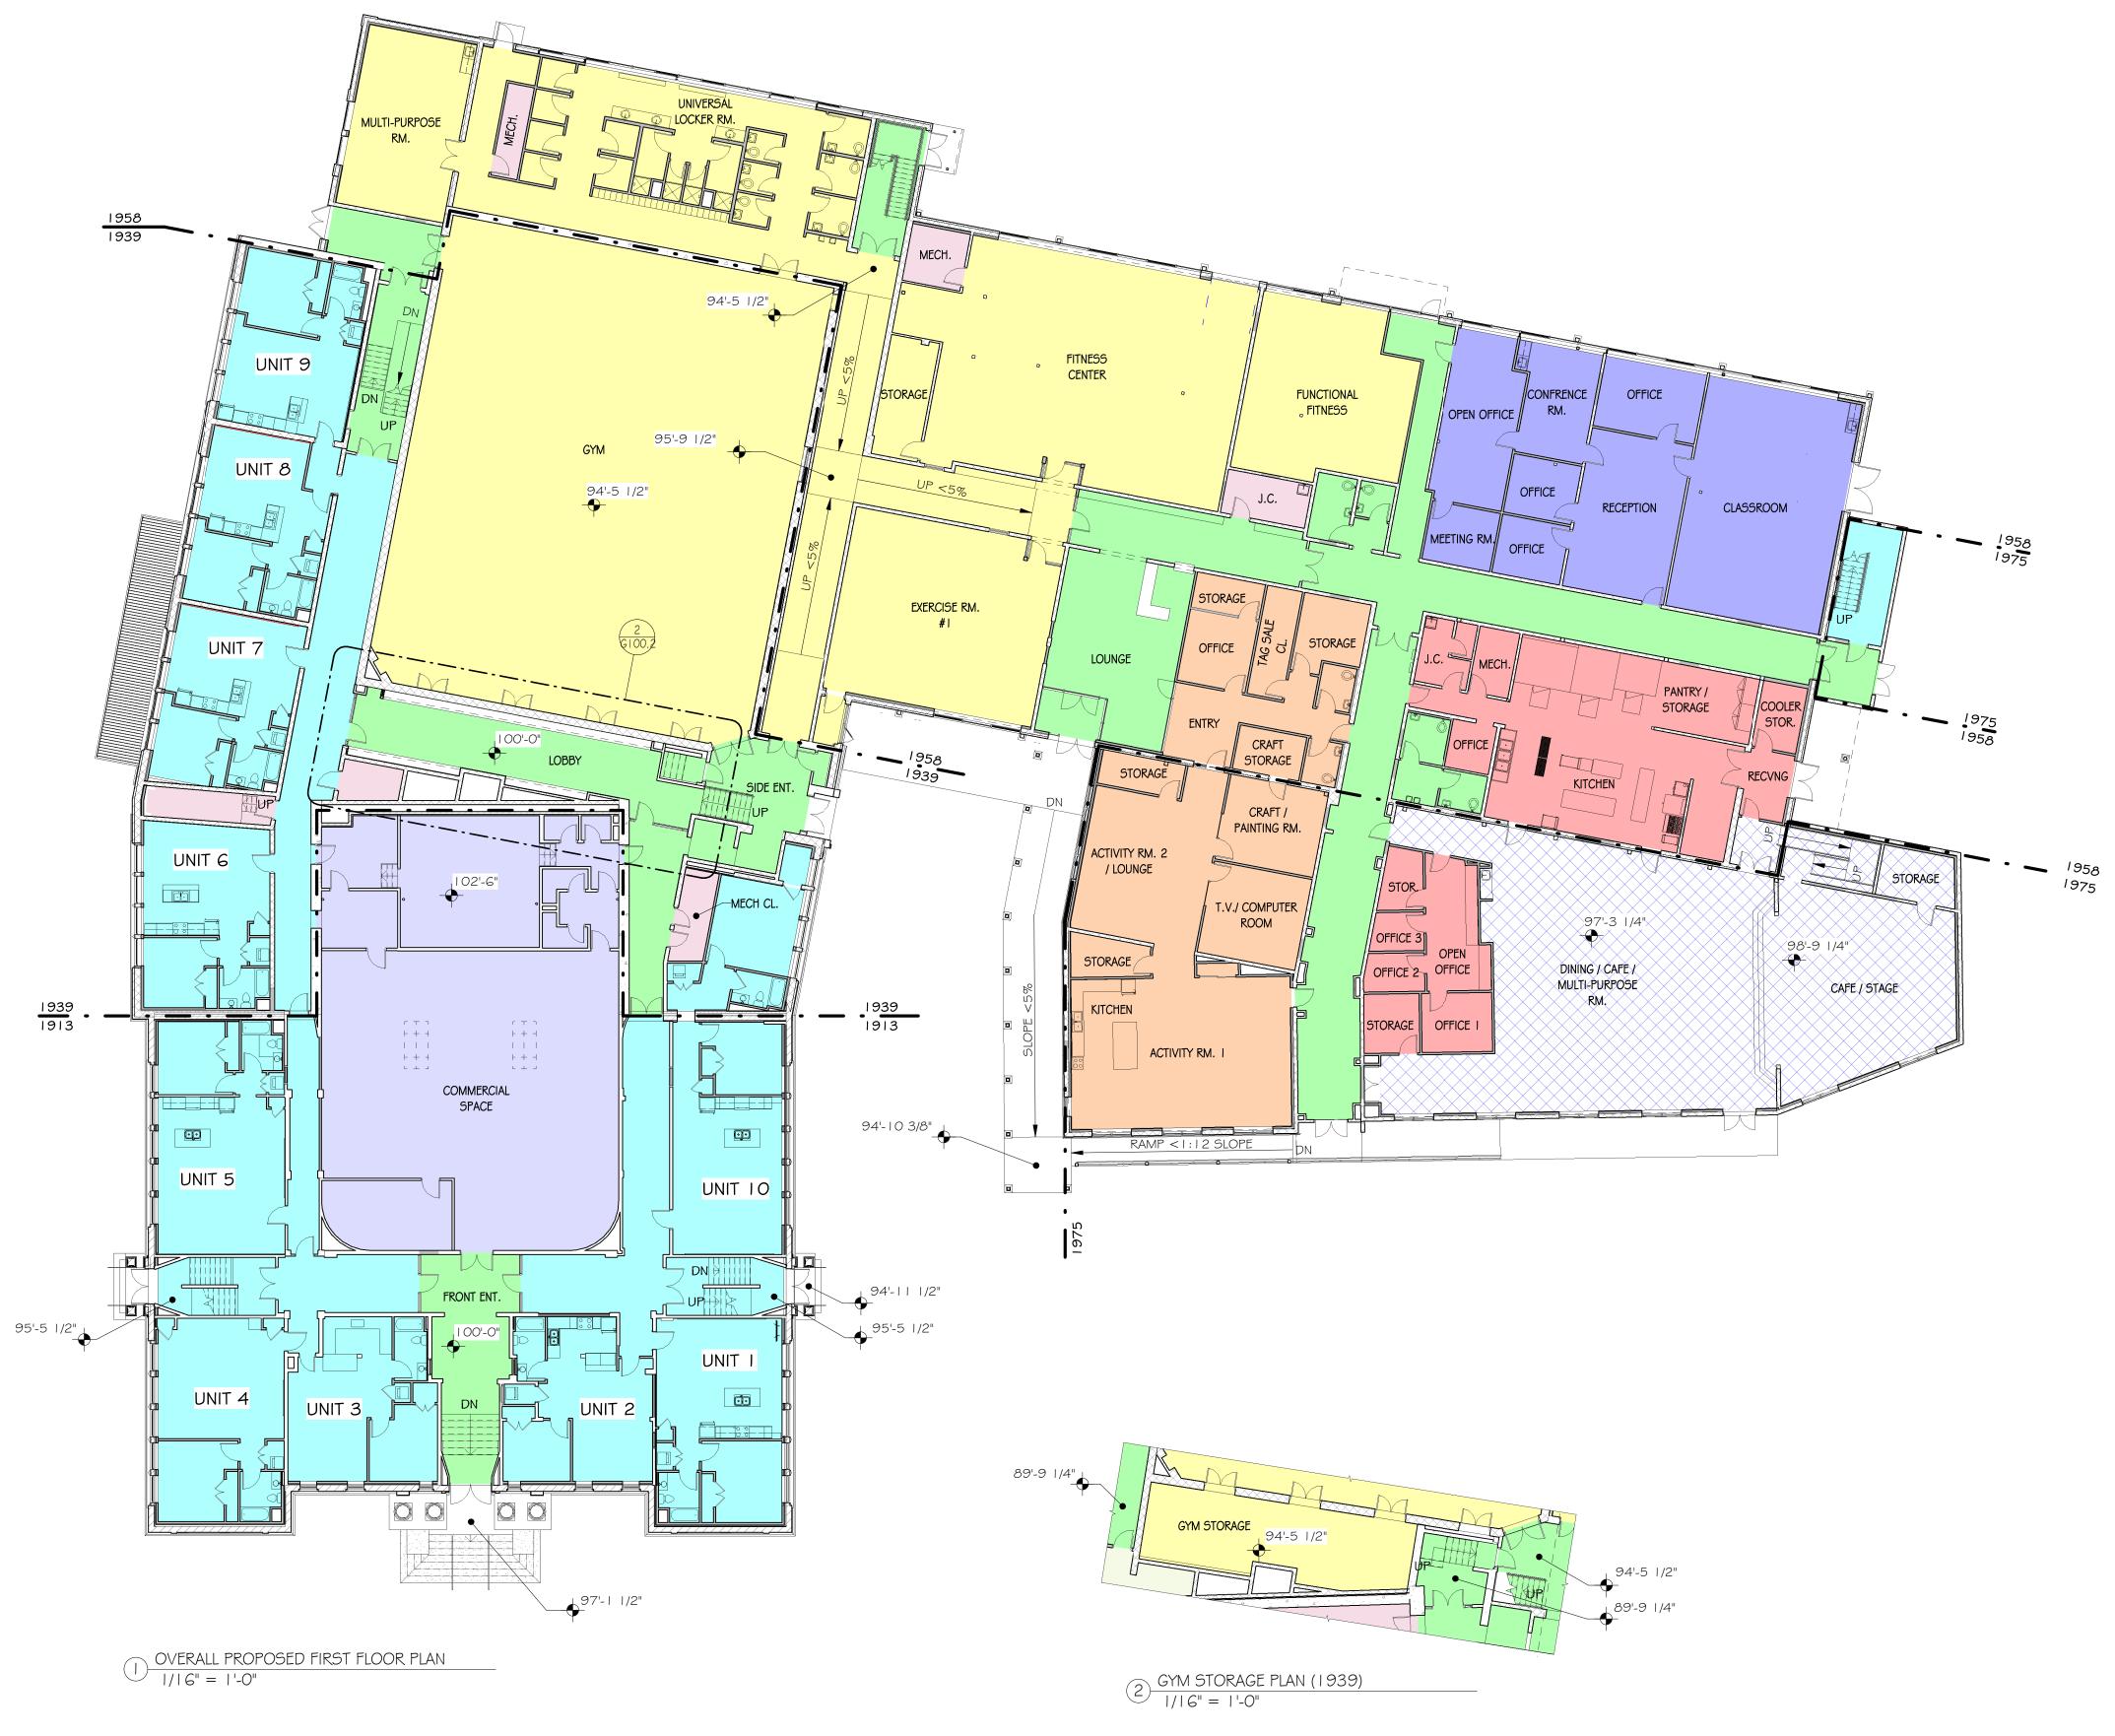




BUILDING OCCUPANTS

| GOLDSTONE ARCHITECTURE<br>150 DEPOT STREET   |  |  |
|--|--|--|
| P.O. BOX 139<br>BENNINGTON, VERMONT 05201  |  |  |
| (802) 753-7469   |  |  |
|  |  |  |
| GOLDSTONE<br>ARCHITECTURE  |  |  |
| CONSULTANTS  |  |  |
| MSK  |  |  |
| ENGINEERING & DESIGN   |  |  |
| MSK Engineering & Design, INC.<br>P.O. Box 139, 150 Depot Street<br>Bennington, VT 05201<br>PH: (802) 447-1402 FAX: (802) 445-1291 |  |  |
| ENGINEERING PLLC<br>structural solutions   |  |  |
| SB Engineering, PLLC<br>900 Rt. 149<br>Clifton Park, NY 12065<br>PH: (518) 724-0733  |  |  |
|  |  |  |
|  |  |  |
| VermontMassachusetts208 Flynn Avenue #2J32 Masonic St., Unit EBurlington, VT 05401Northampton, MA 01060                            |  |  |
| (802) 655-1753 (413) 776-9580<br>Fax (802) 655-7628 Inconsulting.com   |  |  |
| KEY PLAN   |  |  |
|  |  |  |
|  |  |  |
| 1939   |  |  |
| 1975   |  |  |
| 1913 BUILDING ERA  |  |  |
| PROJECT  |  |  |
| OLD BENN HIGH  |  |  |
| RE-DEVELOPMENT<br>PROJECT  |  |  |
| HALE RESOURCES   |  |  |
| 650 MAIN ST.<br>BENNINGTON, VT.<br>05201   |  |  |
| PHASE:<br>DESIGN DEVELOPMENT   |  |  |
| MARK DATE DESCRIPTION  |  |  |
|  |  |  |
|  |  |  |
|  |  |  |
|  |  |  |
|  |  |  |
|  |  |  |
| PRELIMINARY  |  |  |
| NOT FOR CONSTRUCTION   |  |  |
|  |  |  |
| PROJECT NUMBER:  |  |  |
| DATE:   03/31/23     DRAWN BY:   TS/EB   |  |  |
| CHECKED BY: JG/JB  |  |  |
| OVERALL PROPOSED FIRST<br>FLOOR PLAN   |  |  |
| G100.2   |  |  |

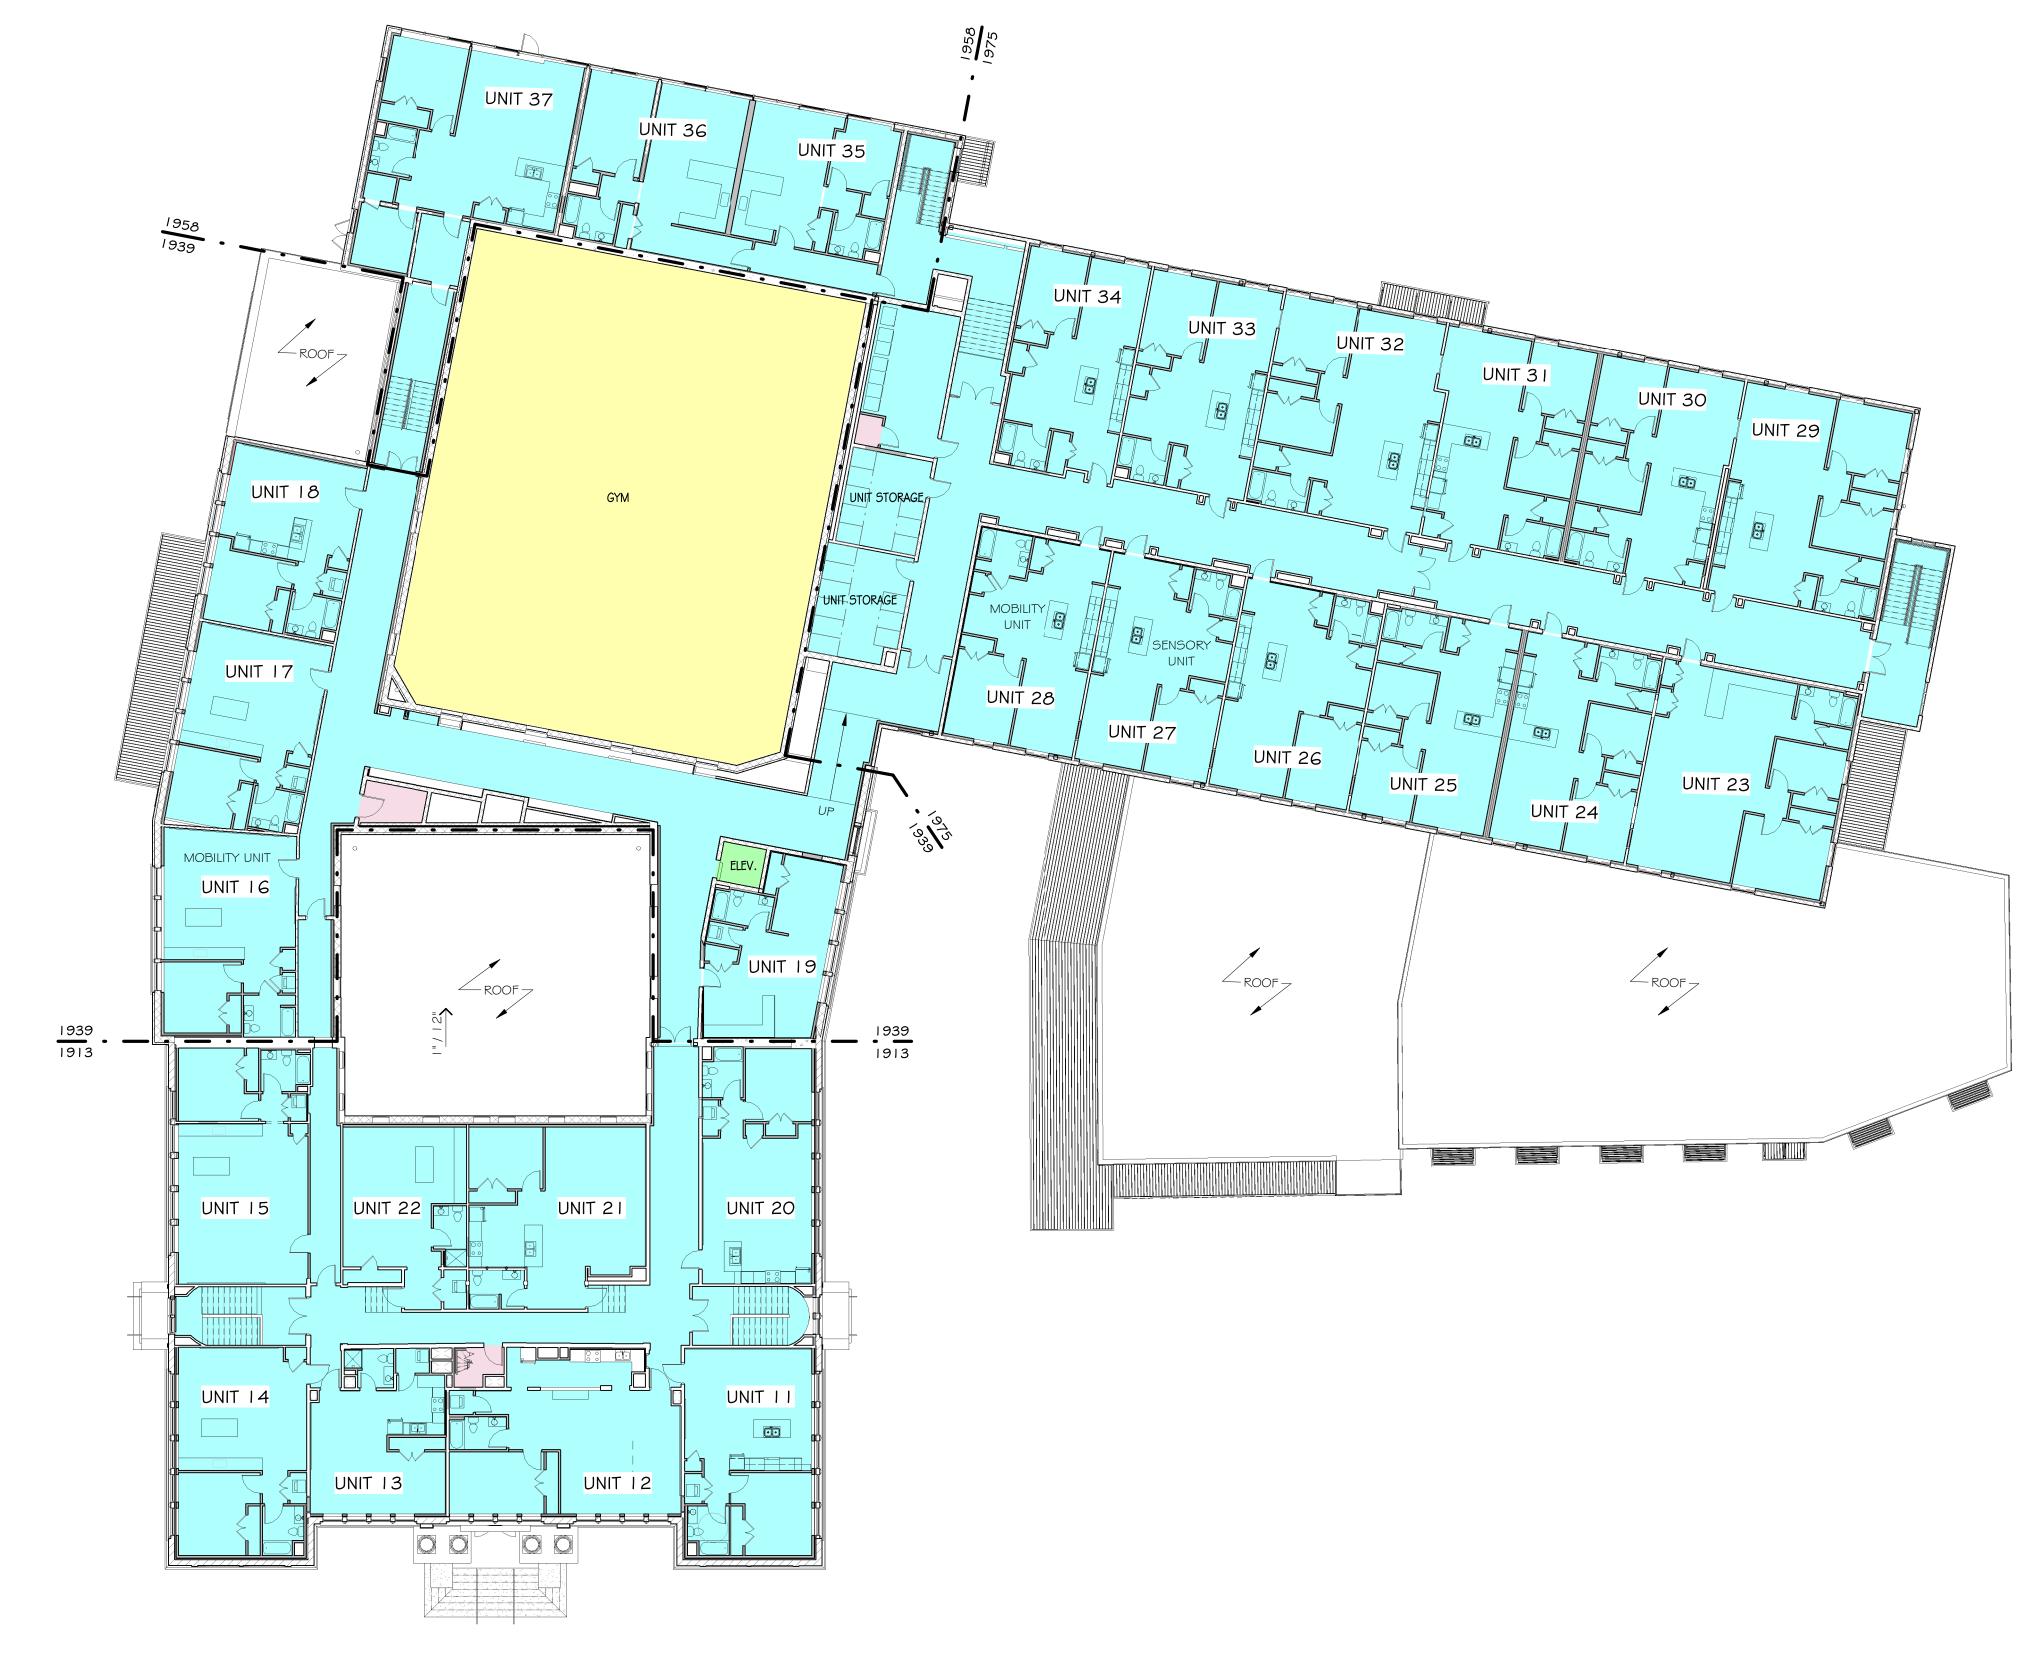

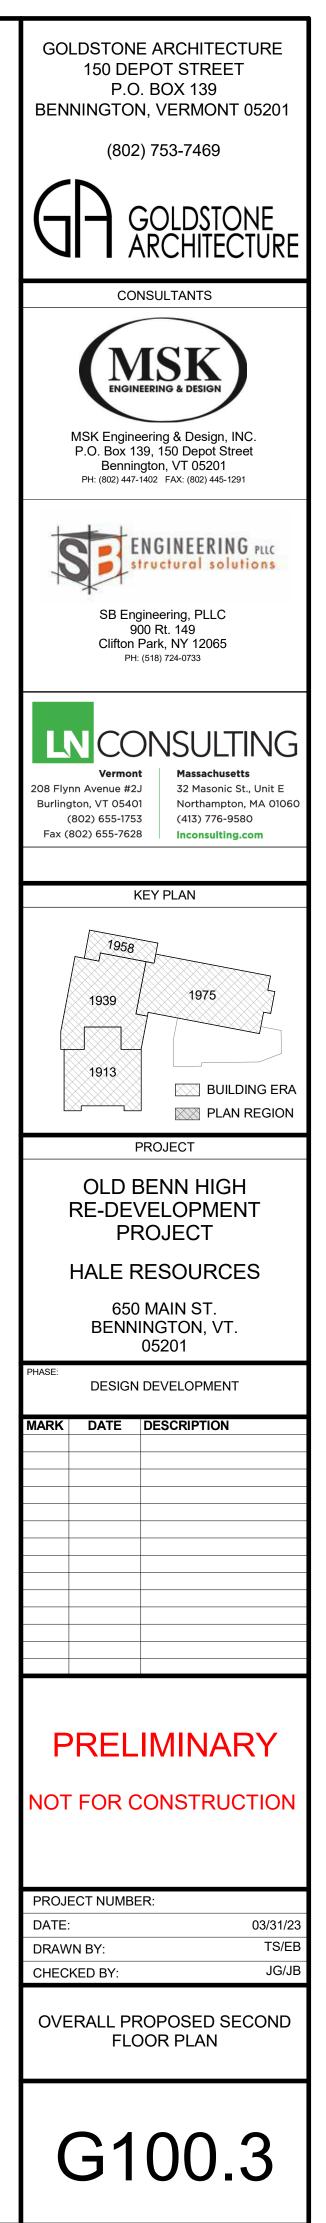

## BUILDING OCCUPANTS



- BUILDING SERVICE AREA
- COMMON / CIRCULATION



| FLOOR PLAN LEGEND                     |                                 |  |  |
|---------------------------------------|---------------------------------|--|--|
|                                       | WALL TO BE REMOVED              |  |  |
|                                       | EXISTING STUD WALL              |  |  |
|                                       | EXISTING BRICK WALL             |  |  |
|                                       | EXISTING STRUCTAL CLAY TILE     |  |  |
|                                       | EXISTING CMU WALL               |  |  |
| , , , , , , , , , , , , , , , , , , , | EXISTING CONCRETE WALL          |  |  |
|                                       | NEW STUD WALL                   |  |  |
|                                       | NEW PARTIAL HEIGHT STUD WALL    |  |  |
|                                       | NEW STUD WALL WITH HIGH WINDOWS |  |  |
|                                       |                                 |  |  |

O IG' 32 SCALE: I/IG" = I'-O"

## 32' 48' $\bigcirc$ $\circ$

48'